ALL WORK TO BE DONE IN ACCORDANCE WITH THE (IRC 2015 NJ EDITION) INTERNATIONAL RESIDENTIAL CODE 2015.

ALL FOOTINGS TO BEAR ON VIRGIN SOIL ONLY.

SOIL BEARING CAPACITY ASSUMED TO BE 3000 PSF. IF ACTUAL SOIL BEARING IS DIFFERENT THAN ASSUMED, NOTIFY ARCHITECT BEFORE PROCEEDING. ARCHITECT NOT RESPONSIBLE FOR VERIFICATION OF SUBSURFACE CONDITIONS OR BEARING CAPACITIES.

STEPPED FOOTINGS (WHERE REQ'D.) TO BE AT A RATIO OF ONE FOOT VERTICAL TO TWO FOOT

- ALL BELOW GRADE BLOCK TO BE HOLLOW LOAD BEARING TYPE.
- ALL CONCRETE TO BE MIN. 3,000 PSI @ 28 DAY STRENGTH. (GARAGE & DRIVEWAY SLAB REQUIRED TO BE 3,500 PSI AIR ENTRAINED CONCRETE).
- ALL MORTAR & GROUT TO BE TYPE "M".
- CONCRETE PROTECTION FOR REINFORCING STEEL SHALL BE 3".
- ALL REINFORCED BARS SHALL BE NEW BILLET STEEL, DEFORMED TYPE, ASTM A615, GRADE 60 & SHALL COMPLY WITH ALL CODE REQUIREMENTS. REBAR TO BE LAPPED (MINIMUM: 20 TIMES THE BAR DIAMETER). ALL FOOTINGS W/ #4 REBAR OR LARGER SHALL PROVIDE GROUNDING WIRE OR REBAR STUB INSTALLED AS PER LOCAL INSPECTORS REQUIREMENTS
- ALL FRAMING LUMBER TO BE DOUGLAS FIR OR SOUTHERN YELLOW PINE NO. 2. MIN.fs=1,300 PSI. ALL LUMBER IN CONTACT WITH MASONRY TO BE TREATED LUMBER (NOTE: INCLUDE GALVANIZED OR STAINLESS STEEL ANCHOR BOLTS, OR USE LSL STRAND GUARD - TREATED SILL.) (NOTE: ALL PILE CONNECTIONS TO BE STAINLESS STEEL.)
- ALL DIMENSIONS ON PLAN ARE FINISHED DIMENSIONS. CONSULT ARCHITECT FOR FRAMING QUESTIONS OR DESCRIPTIONS PRIOR TO FRAMING. DO NOT NOTCH OR CUT LUMBER IN ANY NON TYPICAL MANNER. DISCREPANCIES AND SOLUTIONS SHALL BE REVIEWED AND APPROVED BY ARCHITECT PRIOR TO FRAMING.
- TREATED LUMBER TO BE ACQ WITH REQUIRED FASTENERS, NAILS, ETC.
- DOUBLE ALL JOISTS UNDER PARALLEL PARTITIONS.
- MICROLLAM OR PARALLAM LUMBER TO BE EQUAL TO TRUS-JOIST CORP. MICROLLAM OR PARALLAM LUMBER WITH MIN. (fb=2,900 PSI) (NOTE: MICROLLAMS INDICATED ON PLANS CAN BE SUBSTITUTED WITH PARALLAMS. COMBINATION OF MICROLLAMS CAN BE SUBSTITUTED WITH (1) SOLID MICROLLAM OR PARALLAM WITH EQUAL TOTAL WIDTH AND HEIGHT AS SPECIFIED).
- ALL NAILING TO BE DONE IN ACCORDANCE WITH (NJ IRC 2009) INTERNATIONAL RESIDENTIAL CODE
- ROOM SIZES INDICATED ON PLAN MAY VARY DEPENDING ON EXISTING FIELD CONDITIONS, ETC.
- INTERIOR WOOD TRIM TO BE READY TO RECEIVE PAINT. (CONFIRM STAIN GRADE OPTION WITH HOMEOWNER)(CONFIRM INTERIOR DOOR HEIGHT, STYLE HARDWARE ETC. WITH HOMEOWNER). CONFIRM GYPSUM BOARD RETURNS AT WINDOW WITH HOMEOWNER. DOORS TO BE 7'-0" HIGH
- GYPSUM BOARD IN BATHROOMS TO BE MOISTURE RESISTANT.
- INCLUDE CEMENT BACKER BOARD ON SURFACES RECEIVING TILE.
- WINDOW TO BE ANDERSEN 400 SERIES WITH SCREENS CONFRIM WINDOW SIZES, HARDWARE, COLOR (BLACK CLAD) ETC. WITH HOME OWNER, INCLUDING IMPACT RESISTANT OPTION(S) PROVIDE INTERIOR WINDOW GUARDS AT OPERABLE WINDOW WHERE THE BOTTOM OPENING IS LESS THAN 24" ABOVE FINISH FLOOR (AT UPPER FLOORS)
- ROOF & WALL SHEATHING TO BE 1/2" CDX 32/16 EXTERIOR PLYWOOD.
- INCLUDE ALL NECESSARY STEP FLASHING, VENT STACK FLASHING, ETC. FOR A COMPLETE INSTALLATION. INCLUDE WEATHERWATCH (OR EQUAL) ICE AND WATER SHIELD AT ALL EAVES, VALLEYS, ETC. INCLUDE ALUMINUM FLASHING AT ALL DECK, PORCH, ETC. CONNECTIONS. INSTALL ALL WINDOWS AND DOORS WITH REQUIRED WEATHER SEALS AS SPECIFIED BY MANUFACTURER.
- ELECTRIC LAYOUT IS SCHEMATIC, ALL ELECTRIC WORK TO COMPLY WITH NATIONAL ELECTRIC CODE 2011. CONFIRM ALL ELECTRIC / LIGHTING WITH HOMEOWNER.
- ALL PLUMBING TO COMPLY WITH NATIONAL STANDARD PLUMBING CODE 2015.
- PROVIDE SHUT-OFF VALVES AT ALL FIXTURES.
- THE DESIGN COMPLIES WITH INTERNATIONAL ENERGY CONSERVATION CODE 2015 (RESIDENTIAL)
- CONTRACTOR RESPONSIBLE FOR OBTAINING ALL NECESSARY PERMITS. OWNER RESPONSIBLE FOR COST AND PAYMENT OF PERMITS.
- CONTRACTOR TO VERIFY ALL CONDITIONS AND DIMENSIONS IN FIELD AND BE RESPONSIBLE FOR SINK SAME. CONTRACTOR SHALL INSPECT EXISTING CONDITIONS AND PLAN / COORDINATE ANY REQUIRED CHANGES DUE TO THE PROPOSED CONSTRUCTION AS NECESSARY. CONTRACTOR IS RESPONSIBLE FOR CONTACTING ARCHITECT WITH ANY QUESTIONS, CLARIFICATION, FIELD DISCREPANCIES, CHANGES, ETC.
- ARCHITECT NOT RESPONSIBLE FOR MEANS AND METHODS OF CONSTRUCTION, COORDINATION, AND SCHEDULING OF GENERAL CONTRACTORS AND SUBCONTRACTORS OR ANYONE DIRECTLY OR INDIRECTLY EMPLOYED BY THEM.
- THE CONSTRUCTION DOCUMENTS SHALL BE VALID FOR A PERIOD OF (1) YEAR (BASED ON THE COMPLETION DATE OF THE INITIAL WORKING DRAWINGS). EXPIRED CONSTRUCTION DOCUMENTS SHALL BE REVIEWED BY ARCHITECT FOR NECESSARY REVISIONS DUE TO UPDATED CODES, ORDINANCES, CONSTRUCTION TECHNIQUES, ETC.
- THESE PLANS SHALL NOT BECOME FINAL UNTIL APPROVED BY ALL LOCAL (AND OTHER RELEVANT) DEPARTMENTS, AGENCIES, ETC.; THEREFORE, NO WORK SHALL COMMENCE UNTIL ISSUANCE OF ALL REQUIRED PERMITS.


REMOVE EXISTING WOOD FRAME STRUCTURE DOWN TO EXISTING MASONRY FOUNDATION. INCLUDE REMOVAL OF ALL FRAMING. INCLUDE ADDITIONAL 8"CMU COURSES FOR INCREASED WALK-OUT BASEMENT CEILING HEIGHT. INCLUDE NEW FRAMING AS INDICATED. CUT AND PATCH EXISTING CONCRETE SLAB AS NECESSARY FOR NEW STRCUTURE, PLUMBING, ETC. AS REQUIRED. CONTACT ARCHITECT DURING REMOVAL OF FRAMING AND TOP OF MASONRY WALL(S) FOR OBSERVATION OF EXPOSED STRUCTURE AND POSSIBLE DIRECTION. INCLUDE ALL NEW ELECTRIC, PLUMBING, HVAC, ETC.

NOTE: A SMOKE DETECTOR SYSTEM MEETING THE REQUIREMENTS OF NFPA 72 WILL BE INSTALLED IN THE DWELLING. THIS WILL INCLUDE (1) SMOKE DETECTOR IN EACH BEDROOM, (1) WITHIN 10'-0" OF EACH BEDROOM DOOR AND (1) IN EACH STORY THE SMOKE DETECTORS WILL INCLUDE BATTERY BACK-UP AND WILL BE INTERCONNECTED IN SUCH A MANNER THAT THE ACTUATION OF ONE ALARM WILL ACTUATE ALL OF THE ALARMS.

NOTE: A CARBON MONOXIDE ALARM(S) SHALL BE INSTALLED. THIS ALARM(S) CAN BE BATTERY, PLUG IN OR HARDWIRED TYPE. THE ALARM(S) SHALL BE PLACED IN THE COMMON AREA IN THE VICINITY OF ALL BEDROOMS.

NOTE: HEAT & A.C. TO INCLUDE FORCED AIR SYSTEM(S). SEE DESIGN BY OTHERS. NOTE: ALL WINDOW & DOOR HEADERS TO BE (2)2"x10" UNLESS NOTED OTHERWISE

NOTE: ALL TJI JOISTS, PARALLAMS, AND/OR MICROLLAMS SHALL NOT BE KNOTCHED, CUT, AND/OR DRILLED WITHOUT PRIOR APPROVAL BY ARCHITECT OR

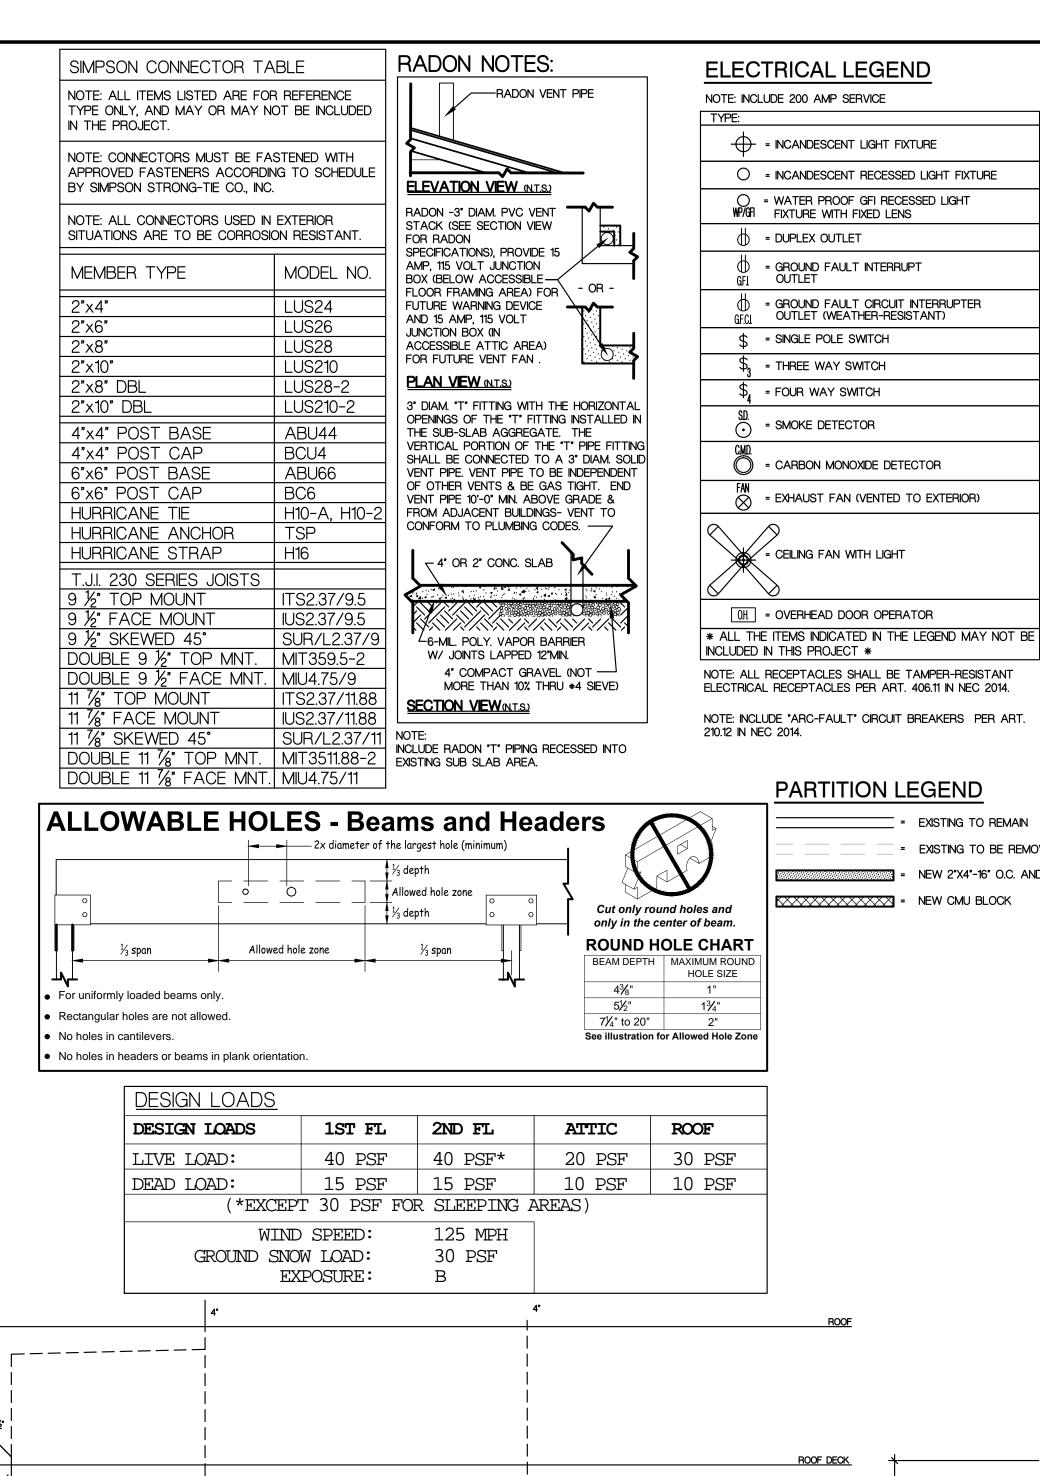

____-

CONFIRM HOSE BIBB LOCATION W


RISER DIAGRAM

BATHROOM

NOTE: SLOPE 1/4" PER 1'-0" (TYP.)

CONFIRM PROPER SEWER DEPTH TO AVOID

PUMP (INCLUDE PUMP AS REQUIRED,)

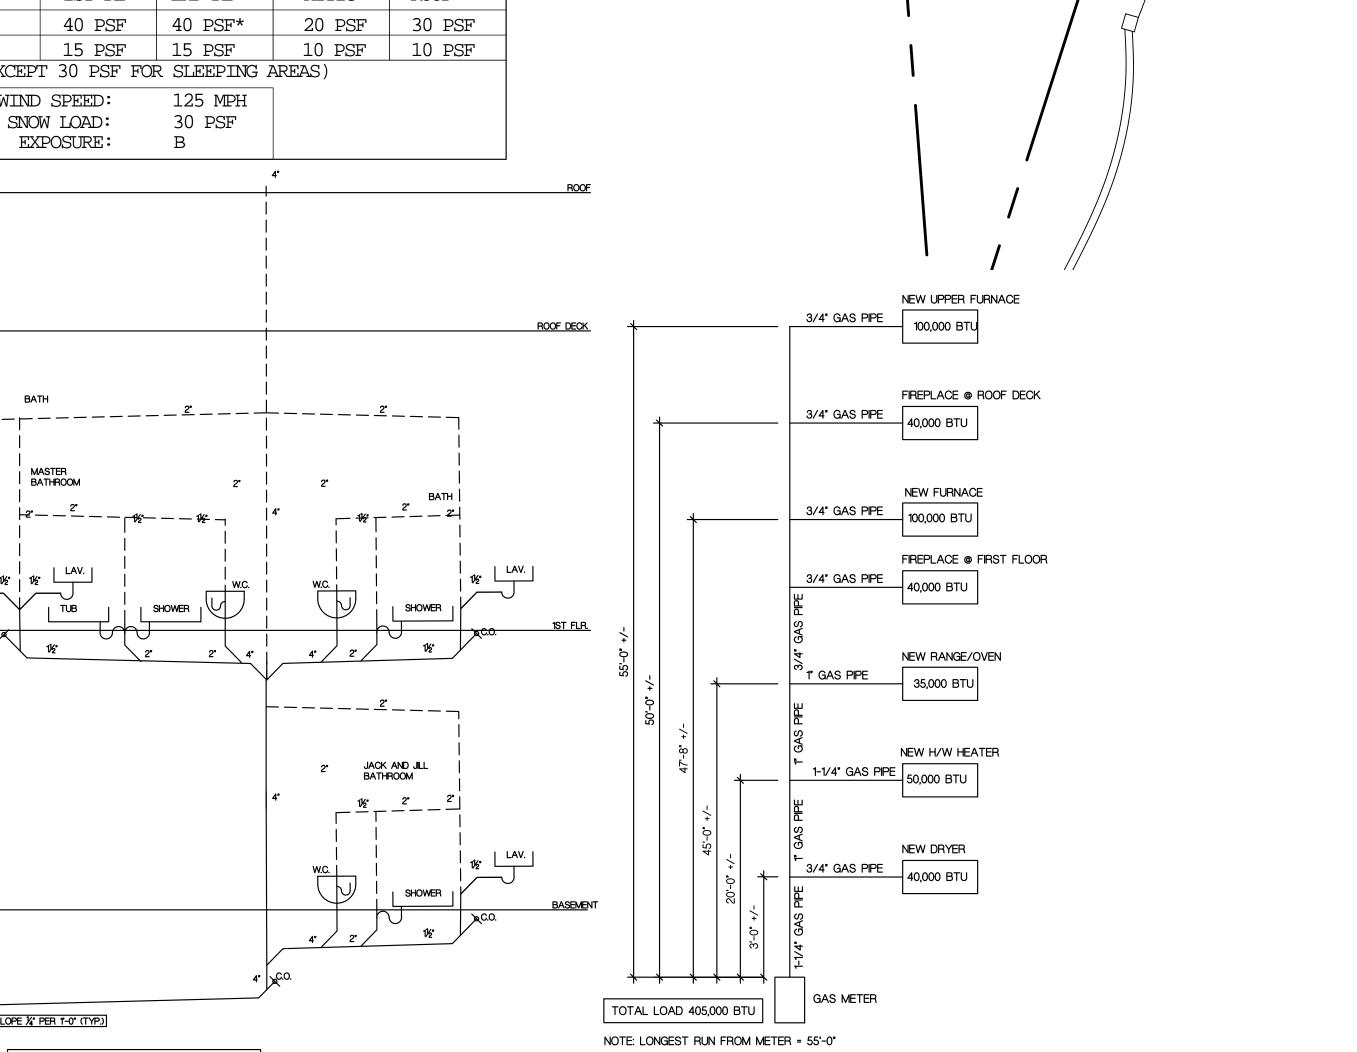

GAS DIAGRAM

EXISTING TO REMAIN

= EXISTING TO BE REMOVED

NEW 2"X4"-16" O.C. AND 2"x6"-16" O,C,

(732) (732) { Kili¹ EXISTING OUTDOOR DECK EXISTING PAVER REMOVED / NU CERT.ND.#AI-11708

ERECT NEW FRAME

STRUCTURE ON EXISTING

HOUSE FOOTPRINT.

REMOVE EXISTING





EXISTING CONDITION

NY LIC. NØ. 034741-1 REGISTERED ARCHITECT

BUILDING DATA HEIGHT OF STRUCTURE: 35'-0" +/-NEW ADDITIONAL AREA: 552 S.F.

VOLUME OF ADD'L STRUCTURE: 15,741 C. VOLUME OF ENTIRE STRUCTURE: 47,860C

USE GROUP: R-5

DESCRIPTION DATE: 02/09/19 ISSUE FOR CLIENT 03/08/19 REVISED PER CLIENT REVIEW 04/17/19 REVISED PER CLIENT REVIEW CONSTRUCTION CHECK PRINT **IREVISED PER** CLIENT REVIEW SSUE FOR BIDS 08/14/19 REVISED PER CLIENT FEEDBACK 09/10/19 RE ISSUE FOR BIDS


09/17/19 RE ISSUE FOR BIDS

DRAWING NUMBER

OF 10

JOB NO. 19-006K



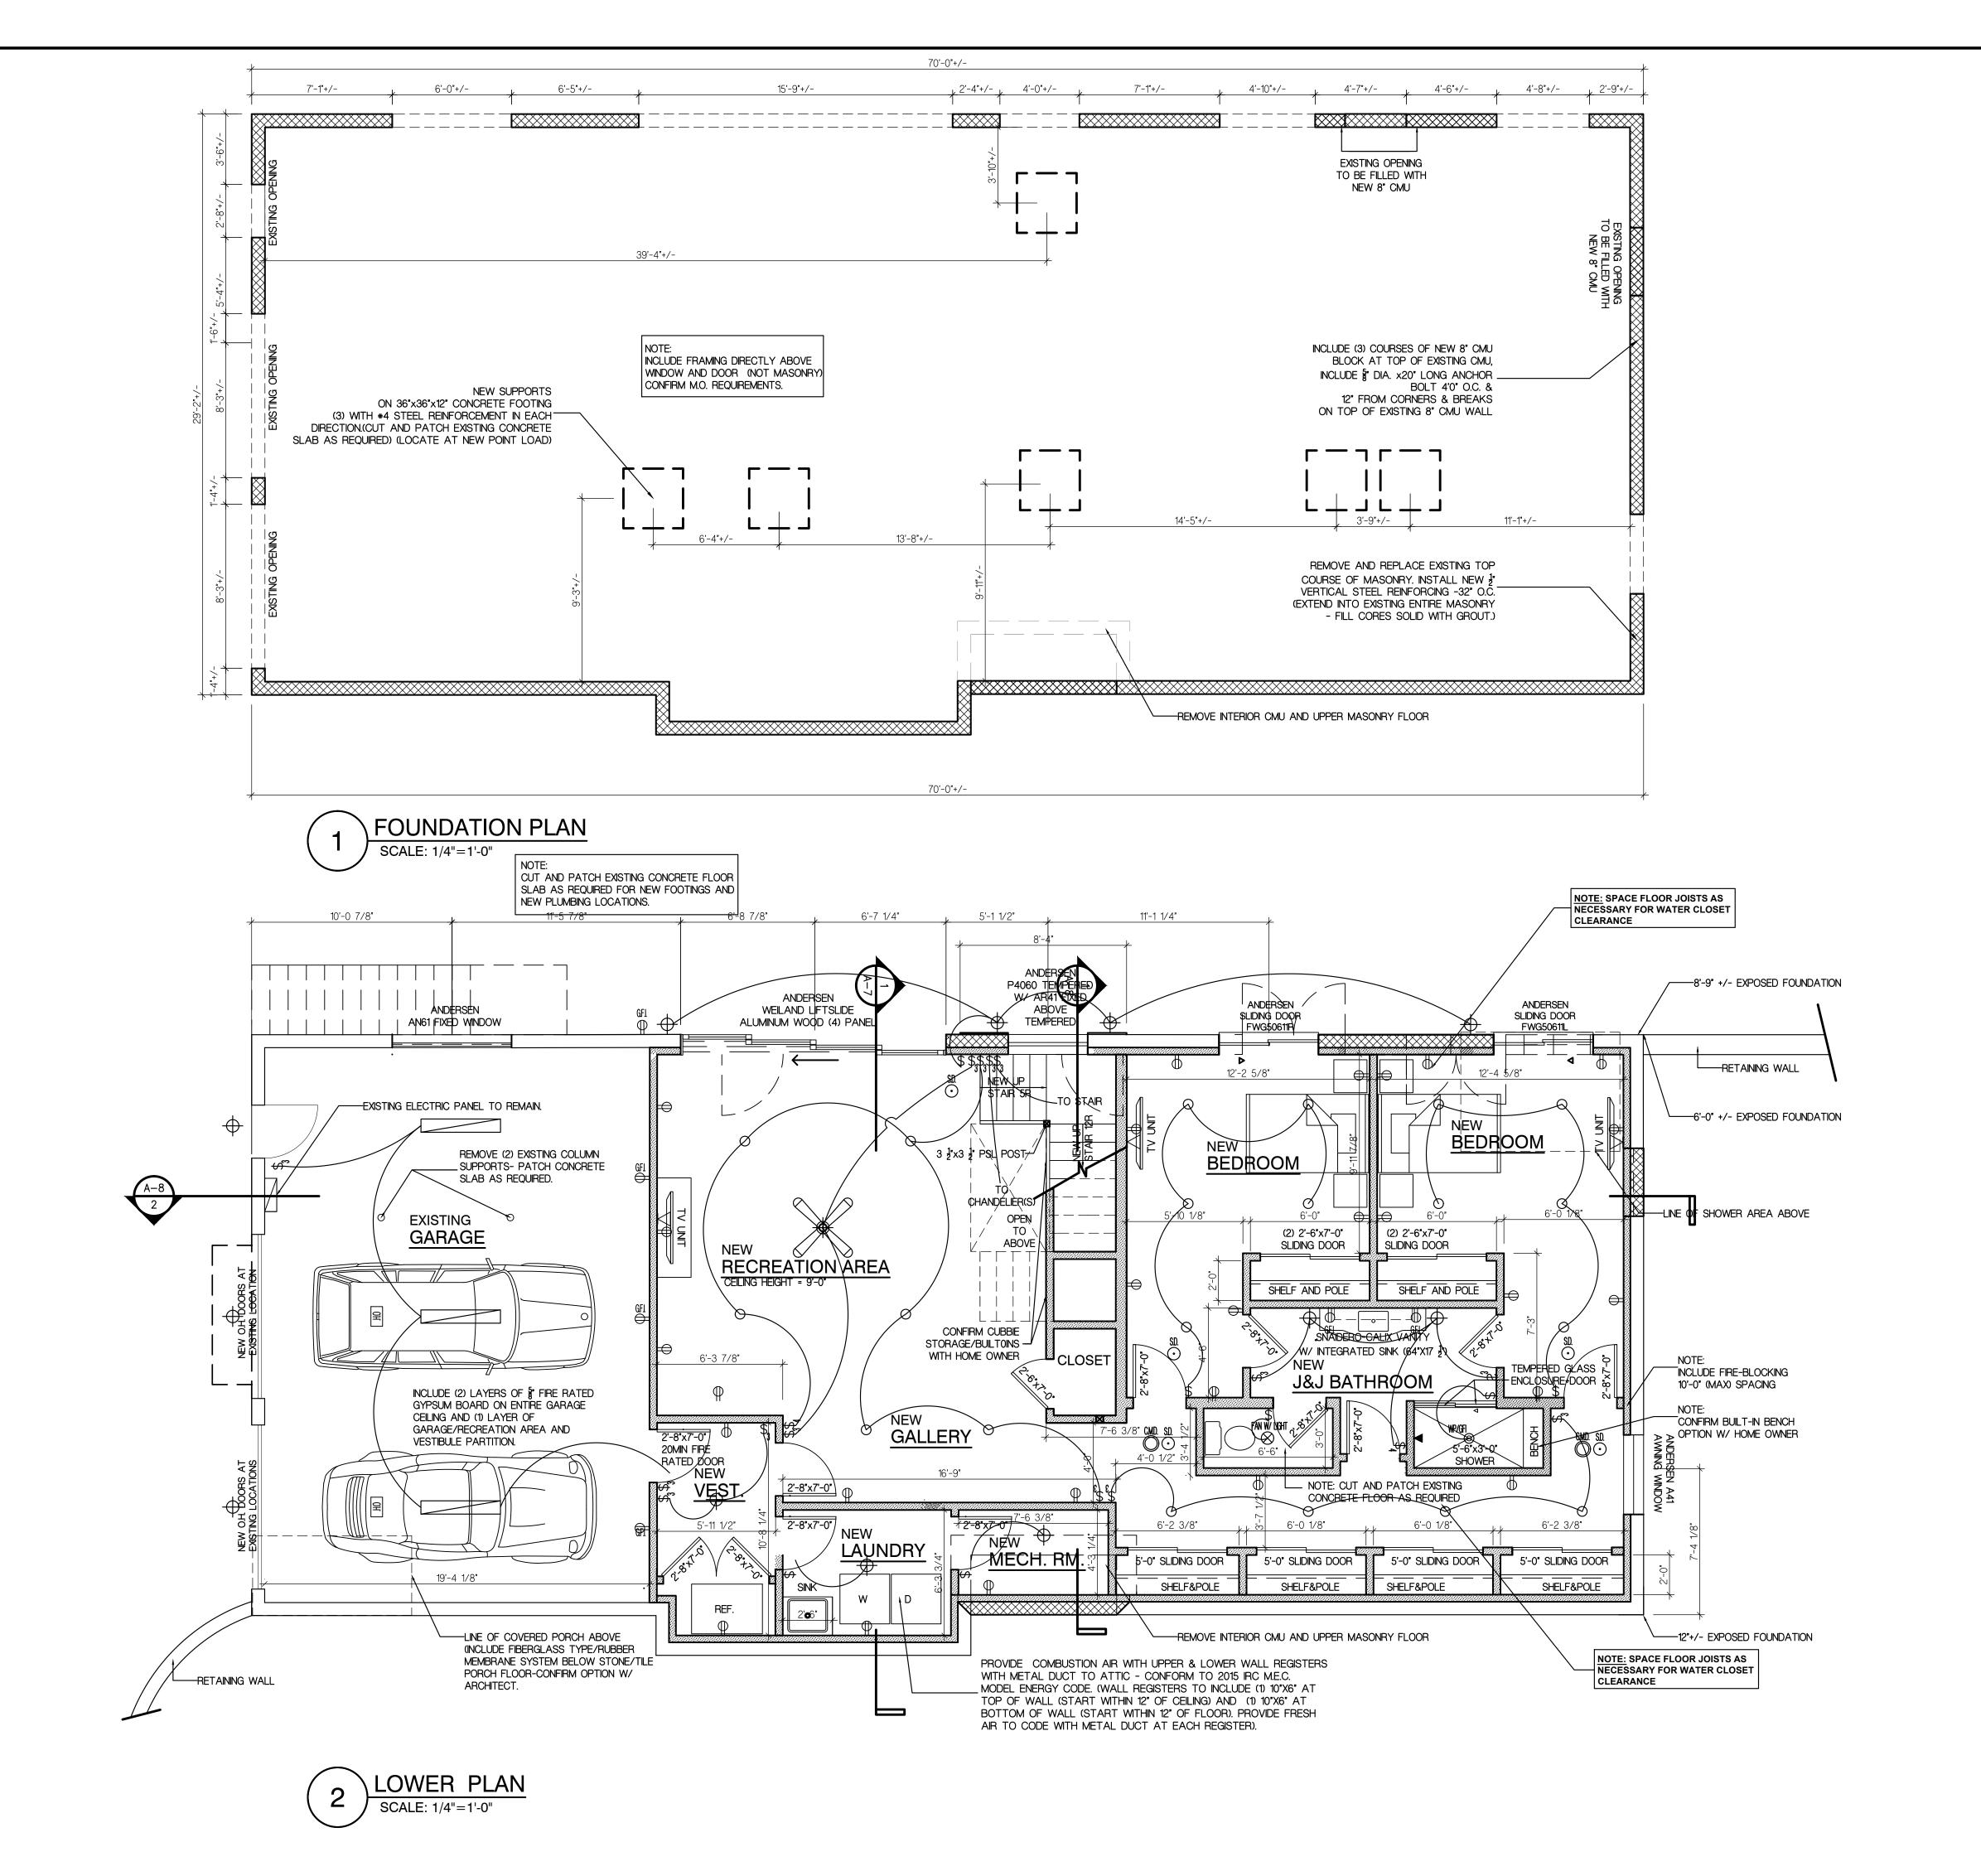

NU CERT.NO.#AI-11708 NY LIC. NO. 034741-1 REGISTERED ARCHITECT

HEIGHT OF STRUCTURE: 35'-0" +/-NEW ADDITIONAL AREA: 552 S.F. VOLUME OF ADD'L STRUCTURE: 15,741 C VOLUME OF ENTIRE STRUCTURE: 47,860C **☆ | DESCRIPTION** ISSUE FOR CLIENT

03/08/19 REVISED PER CLIENT REVIEW REVISED PER CLIENT REVIEW 05/14/19 CONSTRUCTION CHECK PRINT 06/10/19 REVISED PER CLIENT REVIEW ISSUE FOR BIDS REVISED PER

BUILDING DATA

USE GROUP: R-5

DATE:


02/09/19


08/14/19 CLIENT FEEDBACK 09/10/19 RE ISSUE FOR BIDS 09/17/19 RE ISSUE FOR BIDS

DRAWING NUMBER


2 OF 10 JOB NO.

19-006K

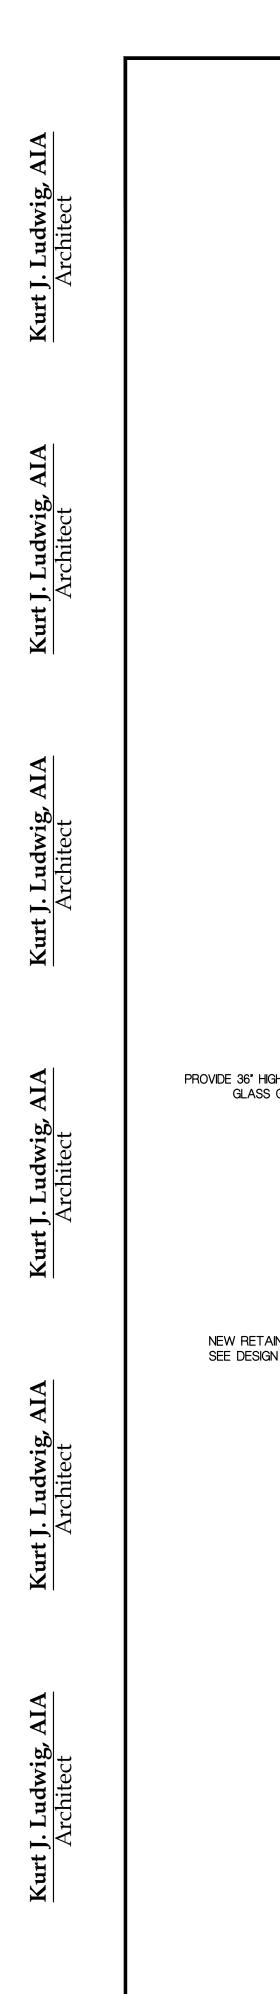


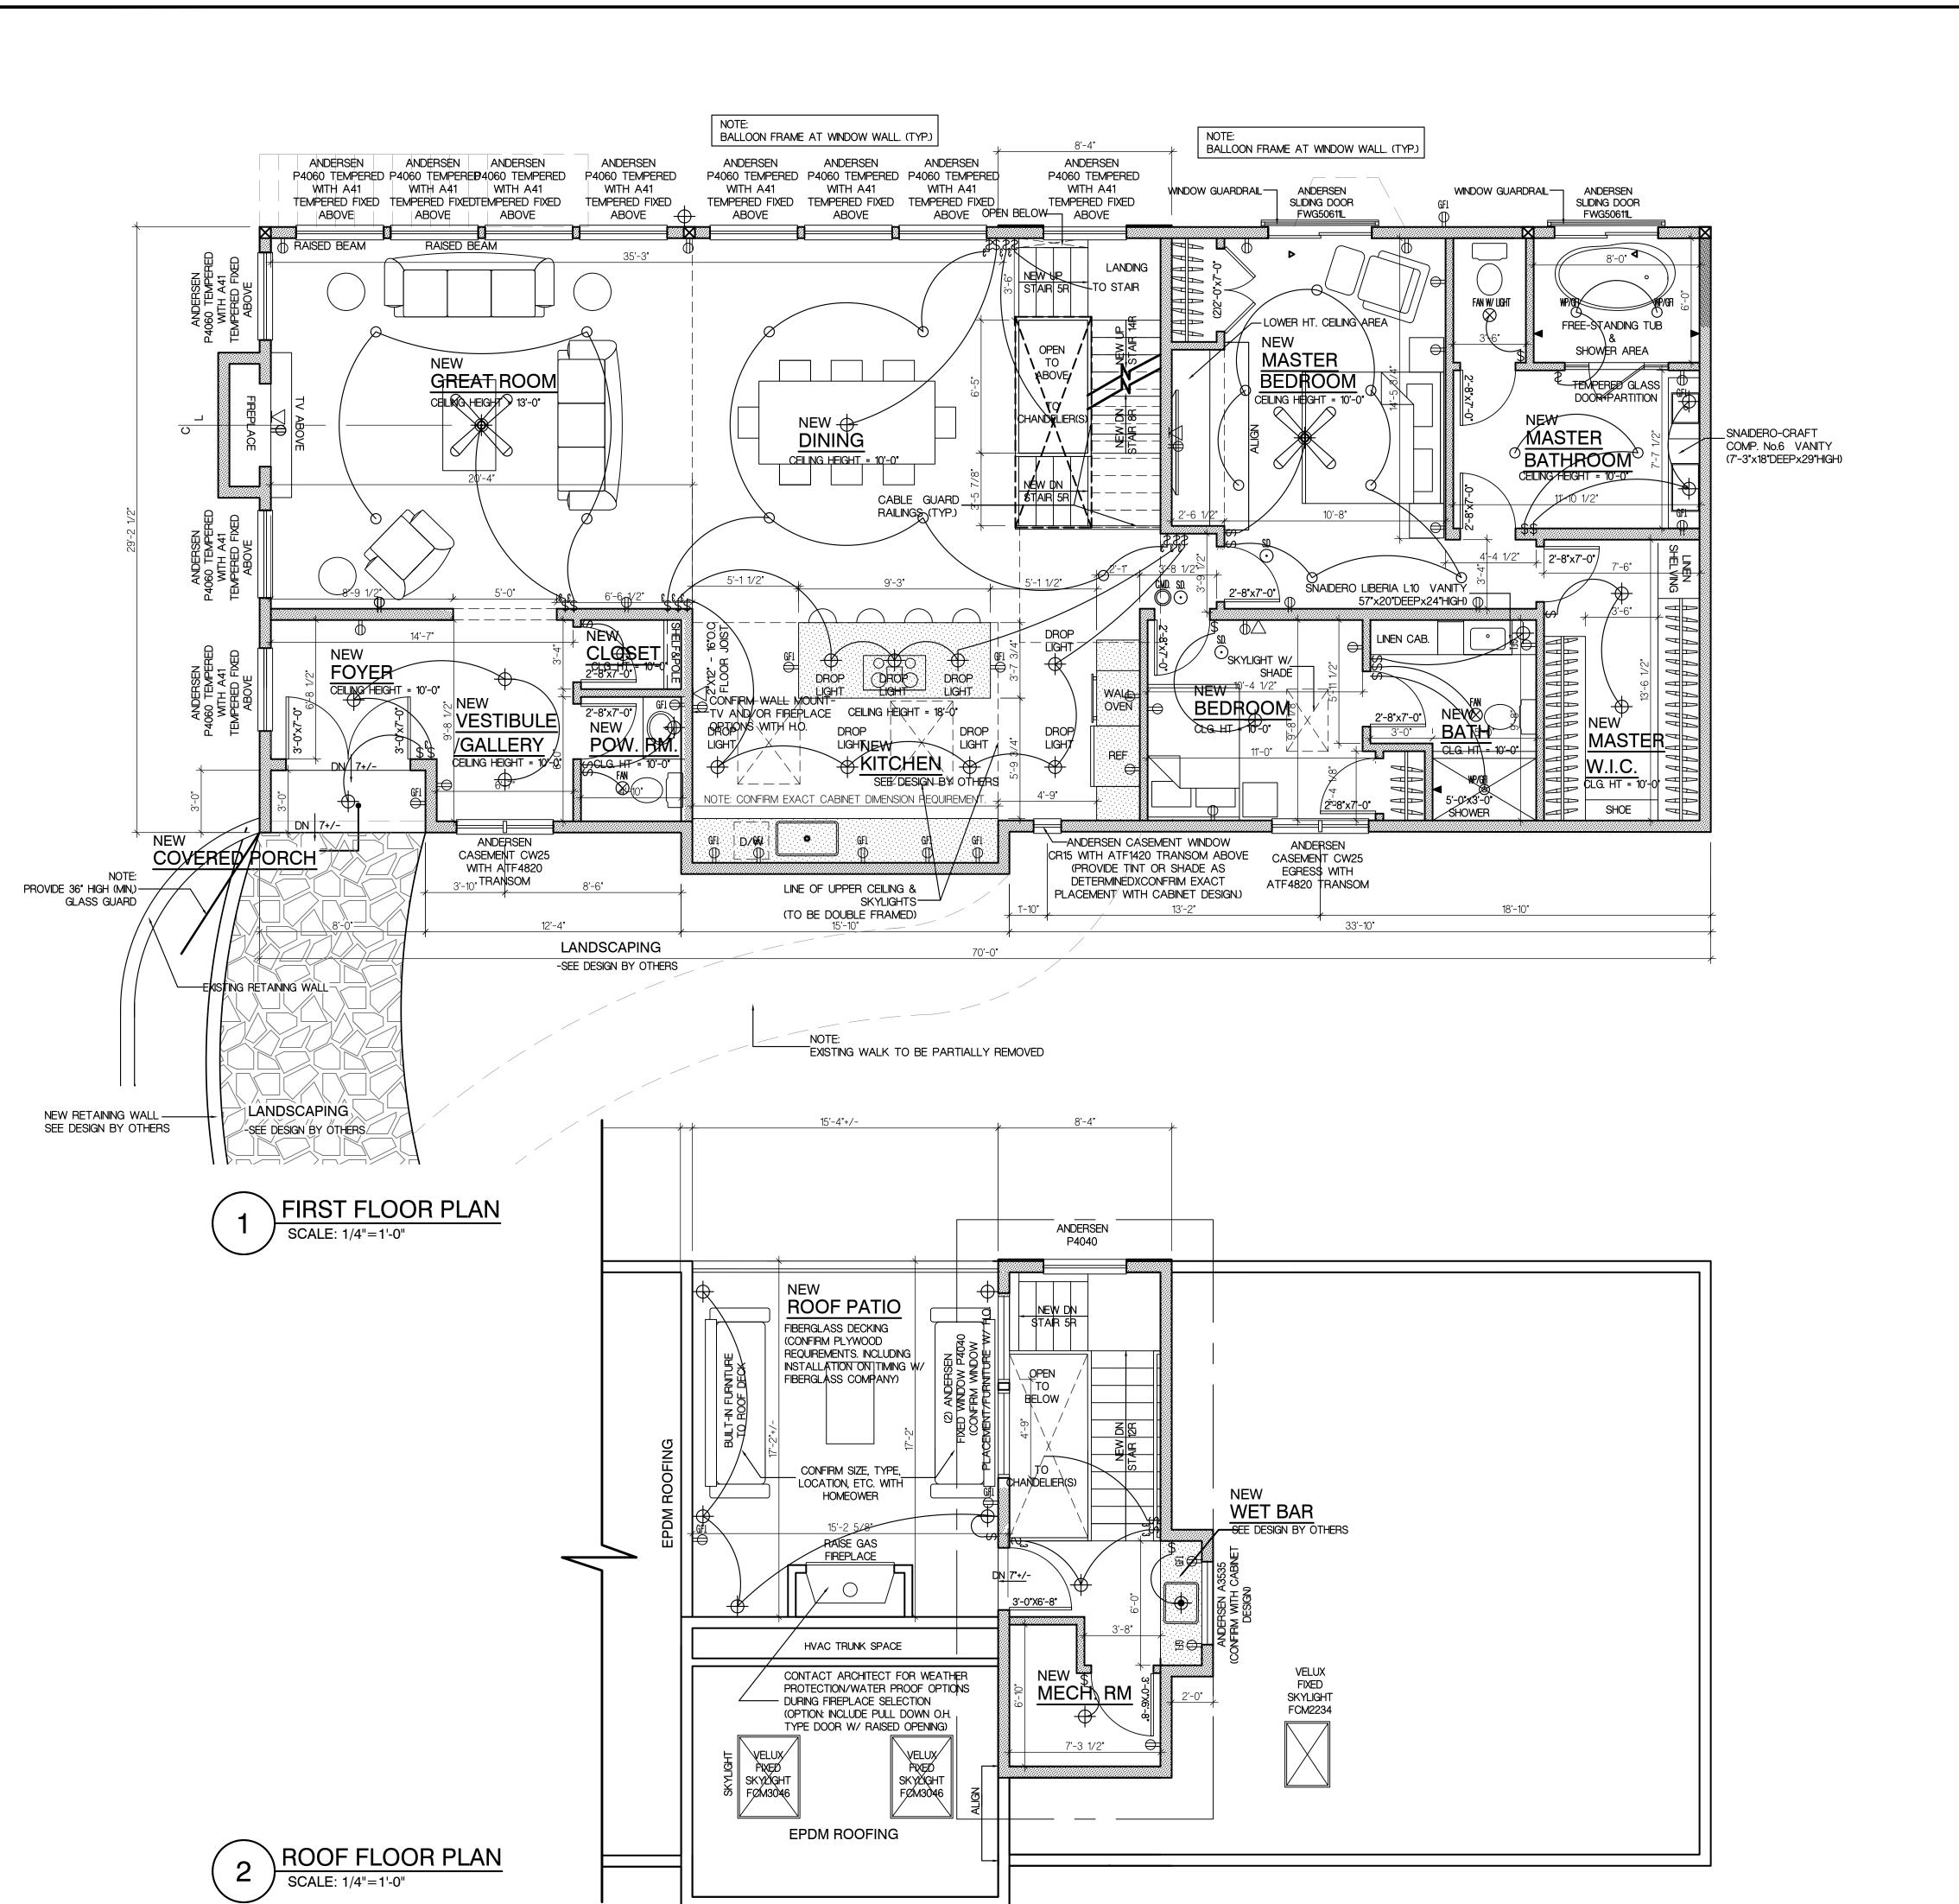


ONE - HOUR FIRE - RESISTANCE - RATED ASSEMBLY FROM (FTO-13) FORMAL TECHNICAL OPINION (FOR SINGLE FAMILY HOUSE WHEN THERE IS LIVING SPACE ABOVE AN ATTACHED GARAGE IN USE GROUP R-3 OR R-4) FLOOR BETWEEN GARAGE AND HOUSE

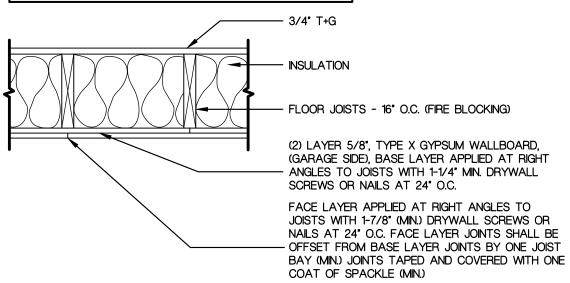

FTO-13 (FLOOR BETWEEN GARAGE & HOUSE) SECTION DETAIL

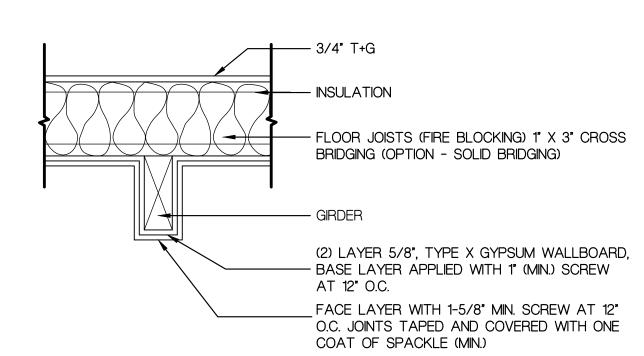

FTO-13 (GARAGE) SCALE: 1"=1'-0"

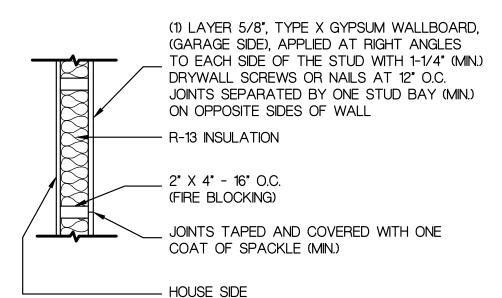

THIS WALL IS CONTINUOUS TO THE UNDERSIDE OF THE CEILING MEMBRANE ABOVE.

FTO-13 (INTERIOR WALL) SECTION DETAIL SCALE: 1"=1'-0"

N CERT.N**/**D.#AI-11708 NY LIC. NO. 034741-1 REGISTERED ARCHITECT

BUILDING DATA HEIGHT OF STRUCTURE: 35'-0" +/-NEW ADDITIONAL AREA: 552 S.F.

VOLUME OF ADD'L STRUCTURE: 15,741 (VOLUME OF ENTIRE STRUCTURE: 47,860C

USE GROUP: R-5

DESCRIPTION DATE: 02/09/19 ISSUE FOR CLIENT 03/08/19 REVISED PER CLIENT REVIEW REVISED PER CLIENT REVIEW 05/14/19 CONSTRUCTION CHECK PRINT 06/10/19 REVISED PER CLIENT REVIEW ISSUE FOR BIDS 08/14/19 REVISED PER CLIENT FEEDBACK 09/10/19 RE ISSUE FOR BIDS

RE ISSUE FOR BIDS


09/17/19

DRAWING NUMBER

3 OF 10 JOB NO.


19-006K



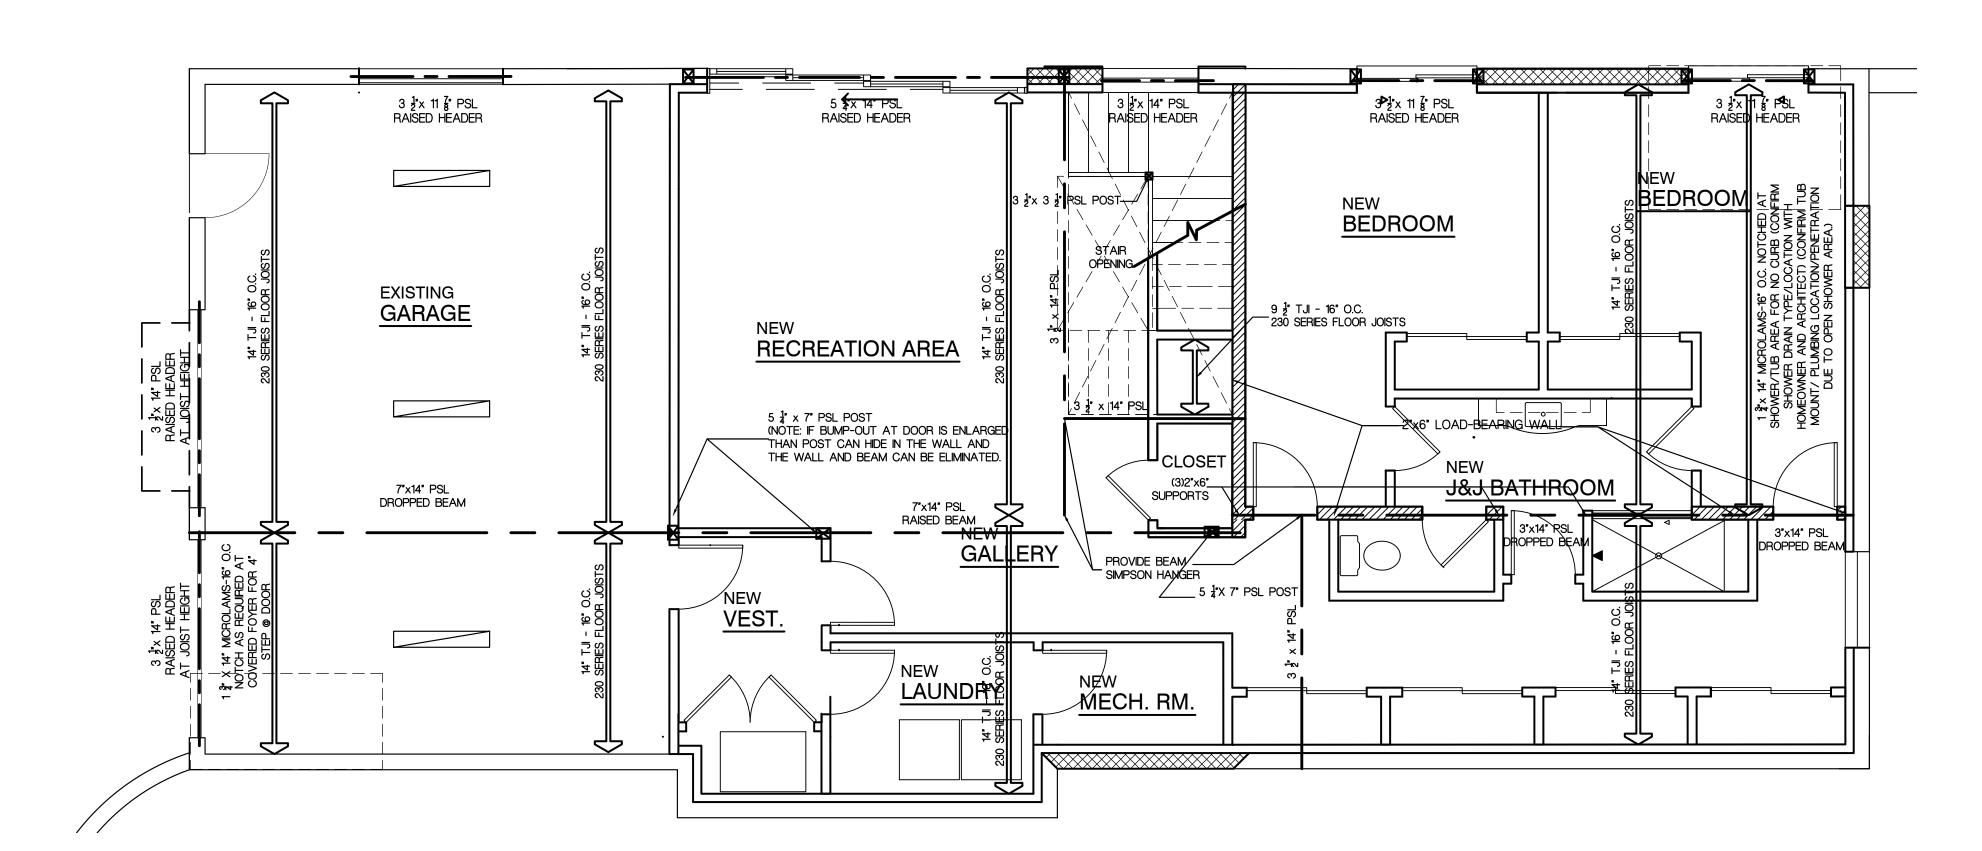


LOWER FLOOR FRAMING PLAN

INCLUDE SIMPSON BEAM CONNECTORS AT ALL POST/COLUMNS, INCLUDING ANCHOR INTO MASONRY. CONSULT ARCHITECT FOR REQUIREMENT. (TYP)

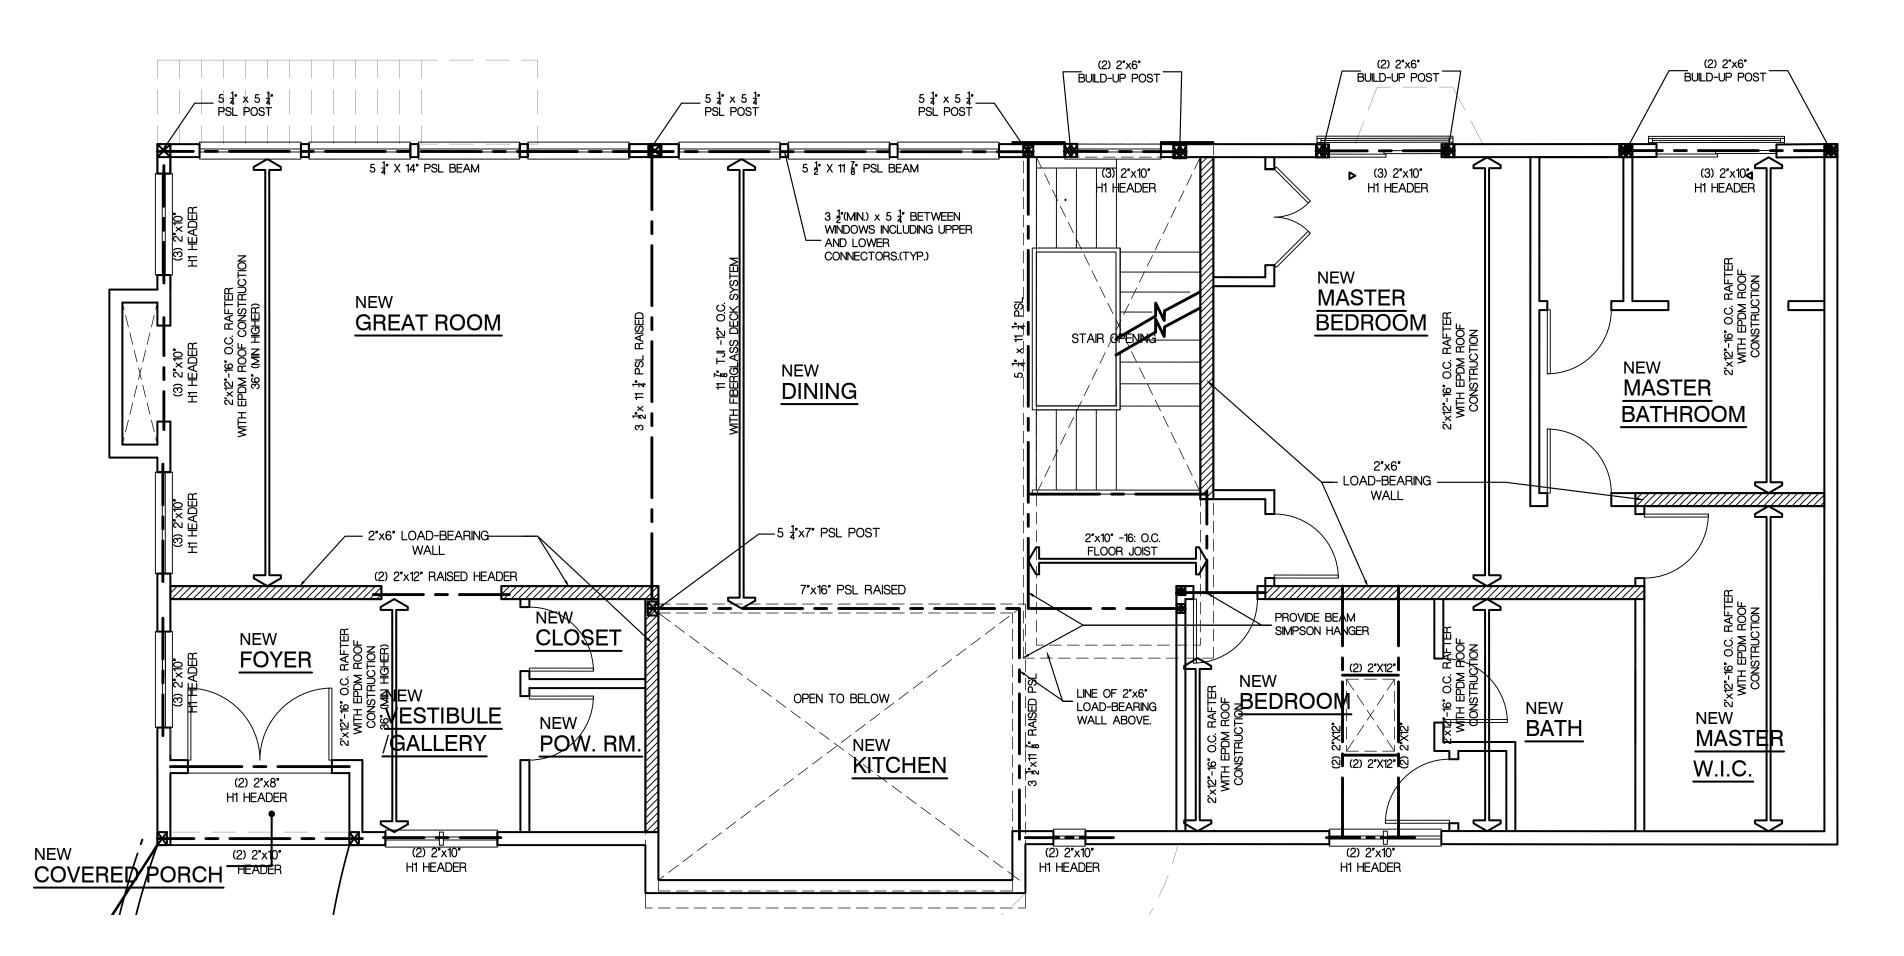



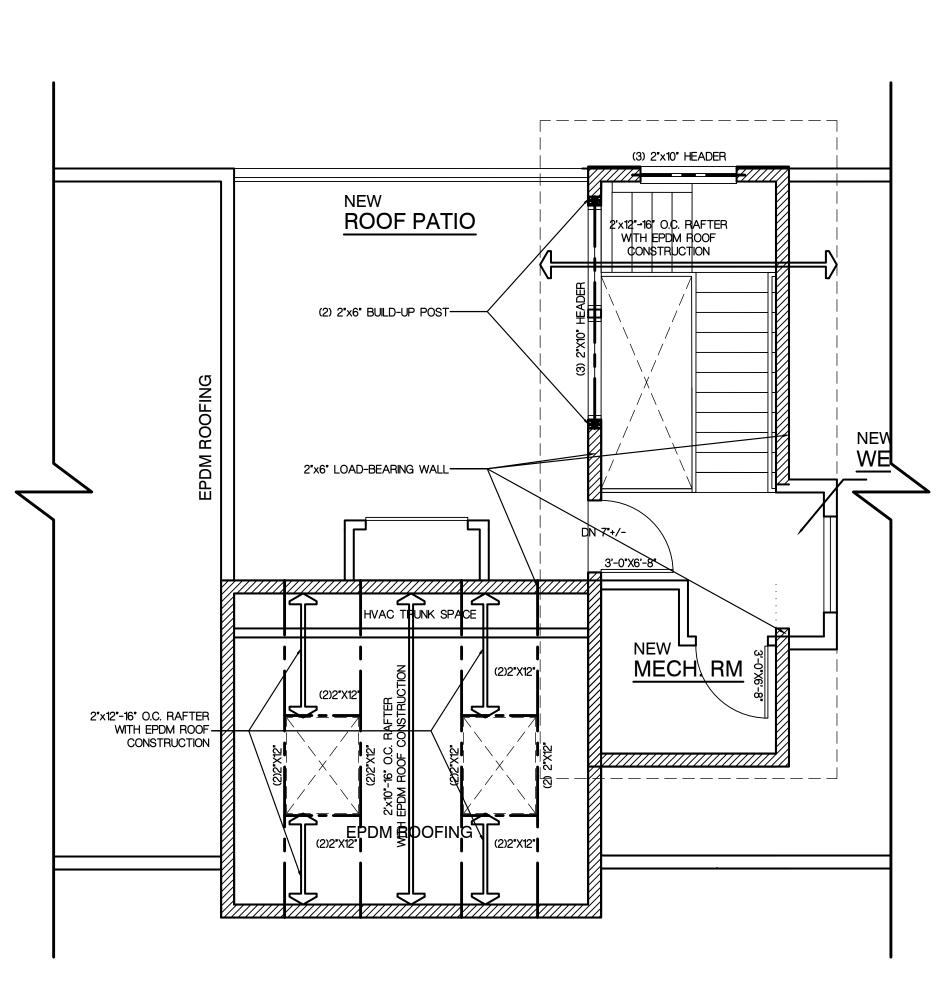

ROOF PLAN FRAMING PLAN SCALE: 1/4"=1'-0"

NU CERT.ND.#AI-11708 NY LIC. NO. 034741-1 REGISTERED ARCHITECT

(732) 846-11 (732) 846-11 .kilndwin

RECONSTRUCTION

RESIDENCE

VIDERE ROAD

BUILDING DATA HEIGHT OF STRUCTURE: 35'-0" +/-NEW ADDITIONAL AREA: 552 S.F.

VOLUME OF ADD'L STRUCTURE: 15,741 (VOLUME OF ENTIRE STRUCTURE: 47,8600

USE GROUP: R-5 DESCRIPTION DATE: 02/09/19 ISSUE FOR CLIENT REVIEW 03/08/19 REVISED PER

CLIENT REVIEW 04/17/19 REVISED PER CLIENT REVIEW 05/14/19 CONSTRUCTION CHECK PRINT 06/10/19 REVISED PER CLIENT REVIEW 07/ /19 ISSUE FOR BIDS 08/14/19 REVISED PER CLIENT FEEDBACK

09/10/19 RE ISSUE FOR BIDS 09/17/19 RE ISSUE FOR BIDS

FRAMING

DRAWING NUMBER

4 OF 10

JOB NO. 19-006K





BUILDING DATA

ISSUE FOR CLIENT REVIEW

REVISED PER CLIENT REVIEW

REVISED PER CLIENT REVIEW

CONSTRUCTION CHECK PRINT

REVISED PER CLIENT REVIEW

ISSUE FOR BIDS

RE ISSUE FOR BIDS

RE ISSUE FOR BIDS


ELEVATIONS

5 OF 10

JOB NO.

19-006K

REVISED PER CLIENT FEEDBACK

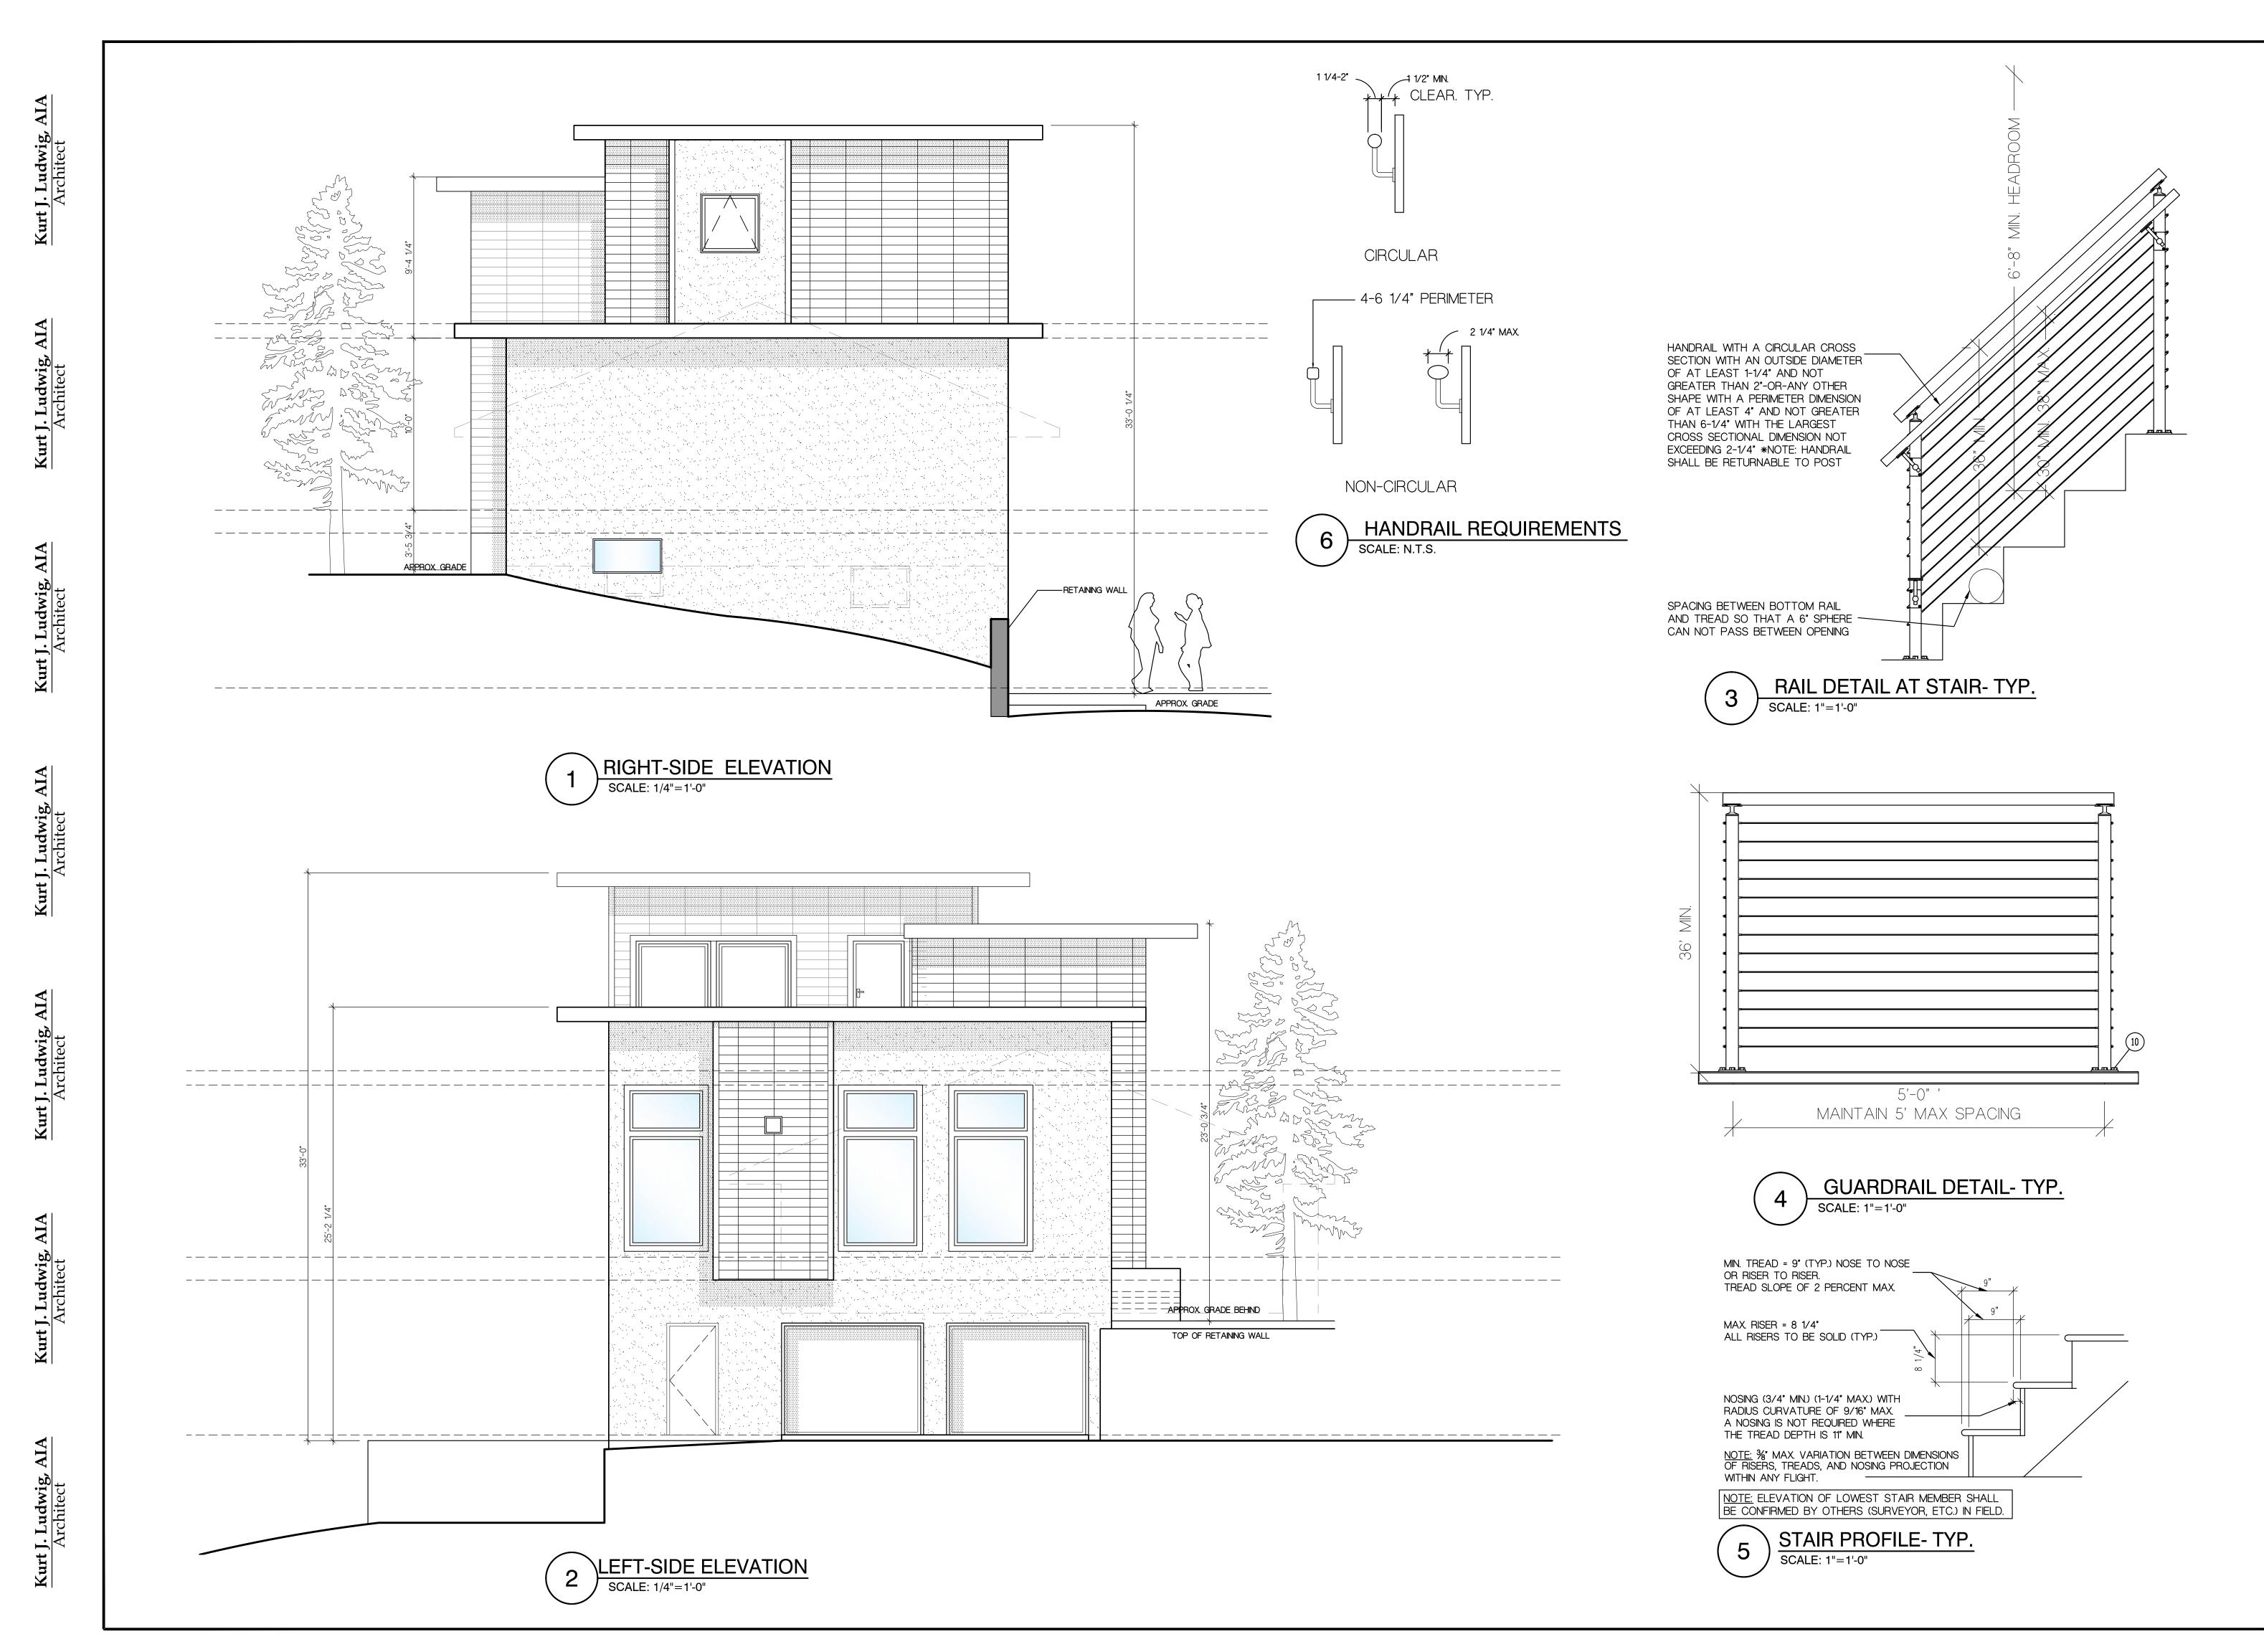

NU CERT.NO.#AI-11708 NY LIC. NO. 034741-1 REGISTERED ARCHITECT

BUILDING DATA HEIGHT OF STRUCTURE: 35'-0" +/-NEW ADDITIONAL AREA: 552 S.F.

VOLUME OF ADD'L STRUCTURE: 15,741 C

VOLUME OF ENTIRE STRUCTURE: 47,860C


ISE GROUP: R-5							
DATE:	REV.	DESCRIPTIO	N: BY:				
02/09/19		ISSUE FOR CLIENT REVIEW	NG				
03/08/19		REVISED PER CLIENT REVIEW	NG				
04/17/19		REVISED PER CLIENT REVIEW	NG				
05/14/19		CONSTRUCTION CHECK PRINT	NG				
06/10/19		REVISED PER CLIENT REVIEW	NG				
07/ /19		ISSUE FOR BIDS	NG				
08/14/19		REVISED PER CLIENT FEEDBACK	NG				
09/10/19		RE ISSUE FOR BIDS	S NG				


RE ISSUE FOR BIDS

09/17/19

DRAWING NUMBER

6 OF 10 JOB NO. 19-006K

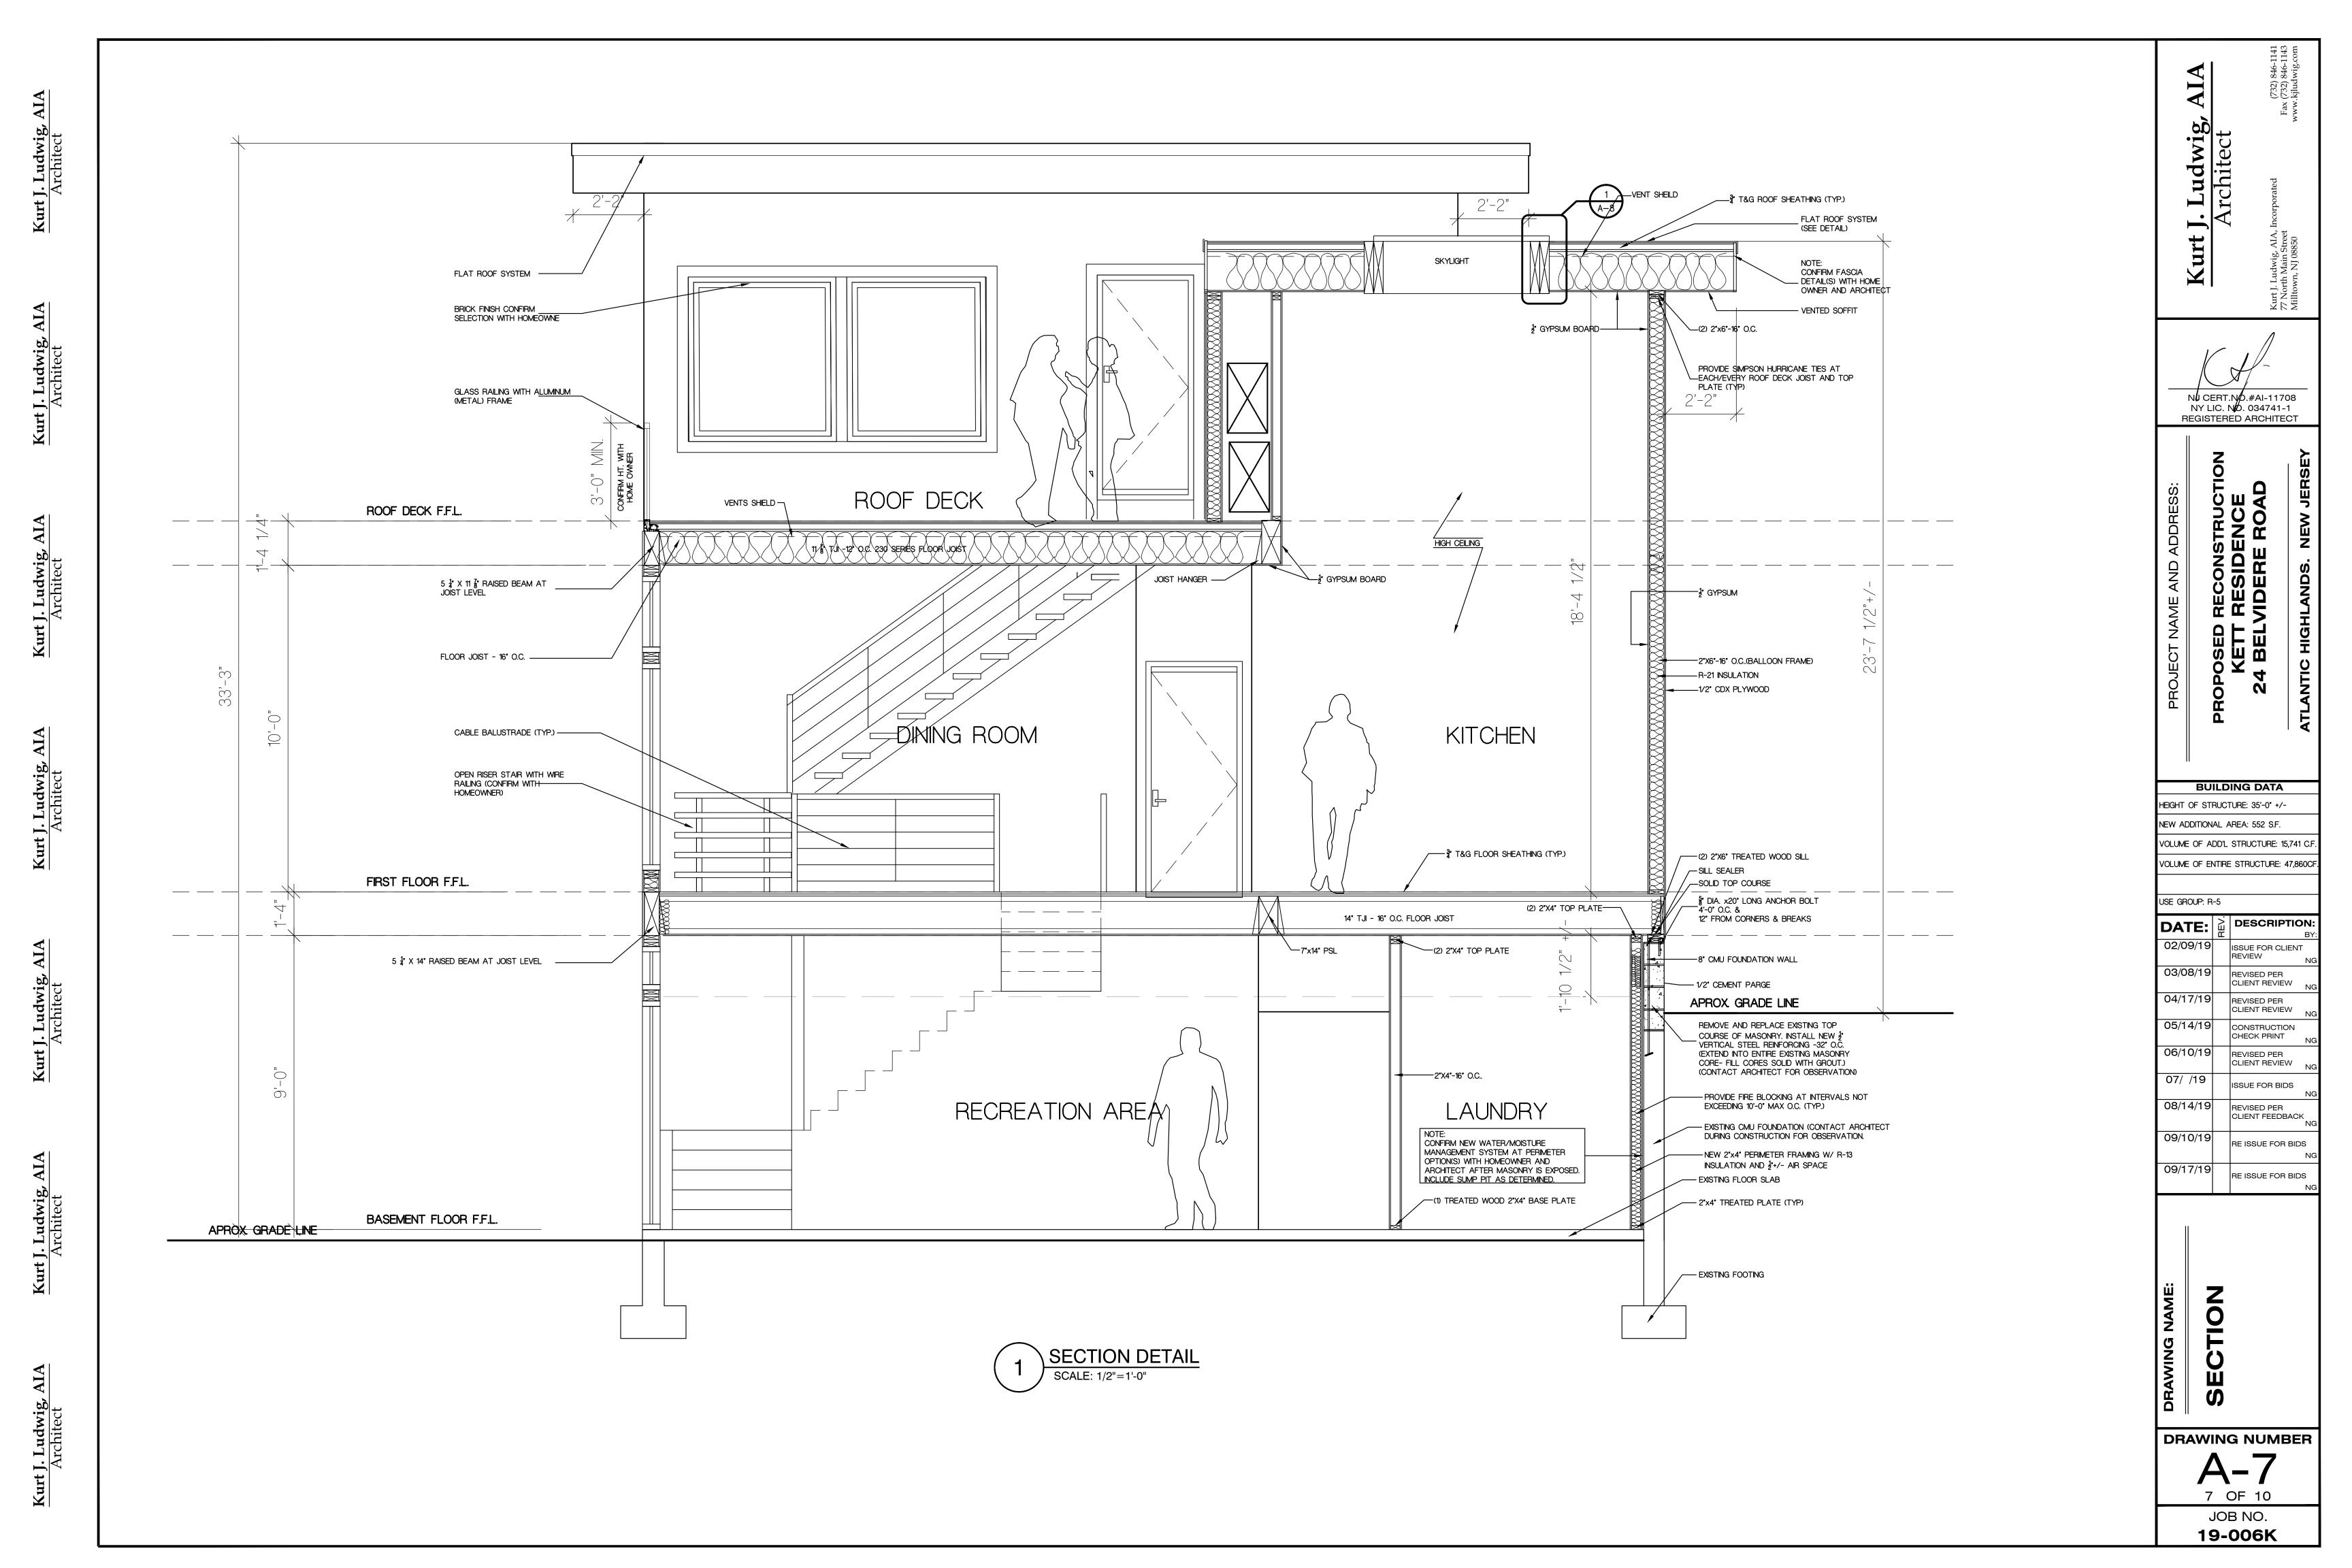

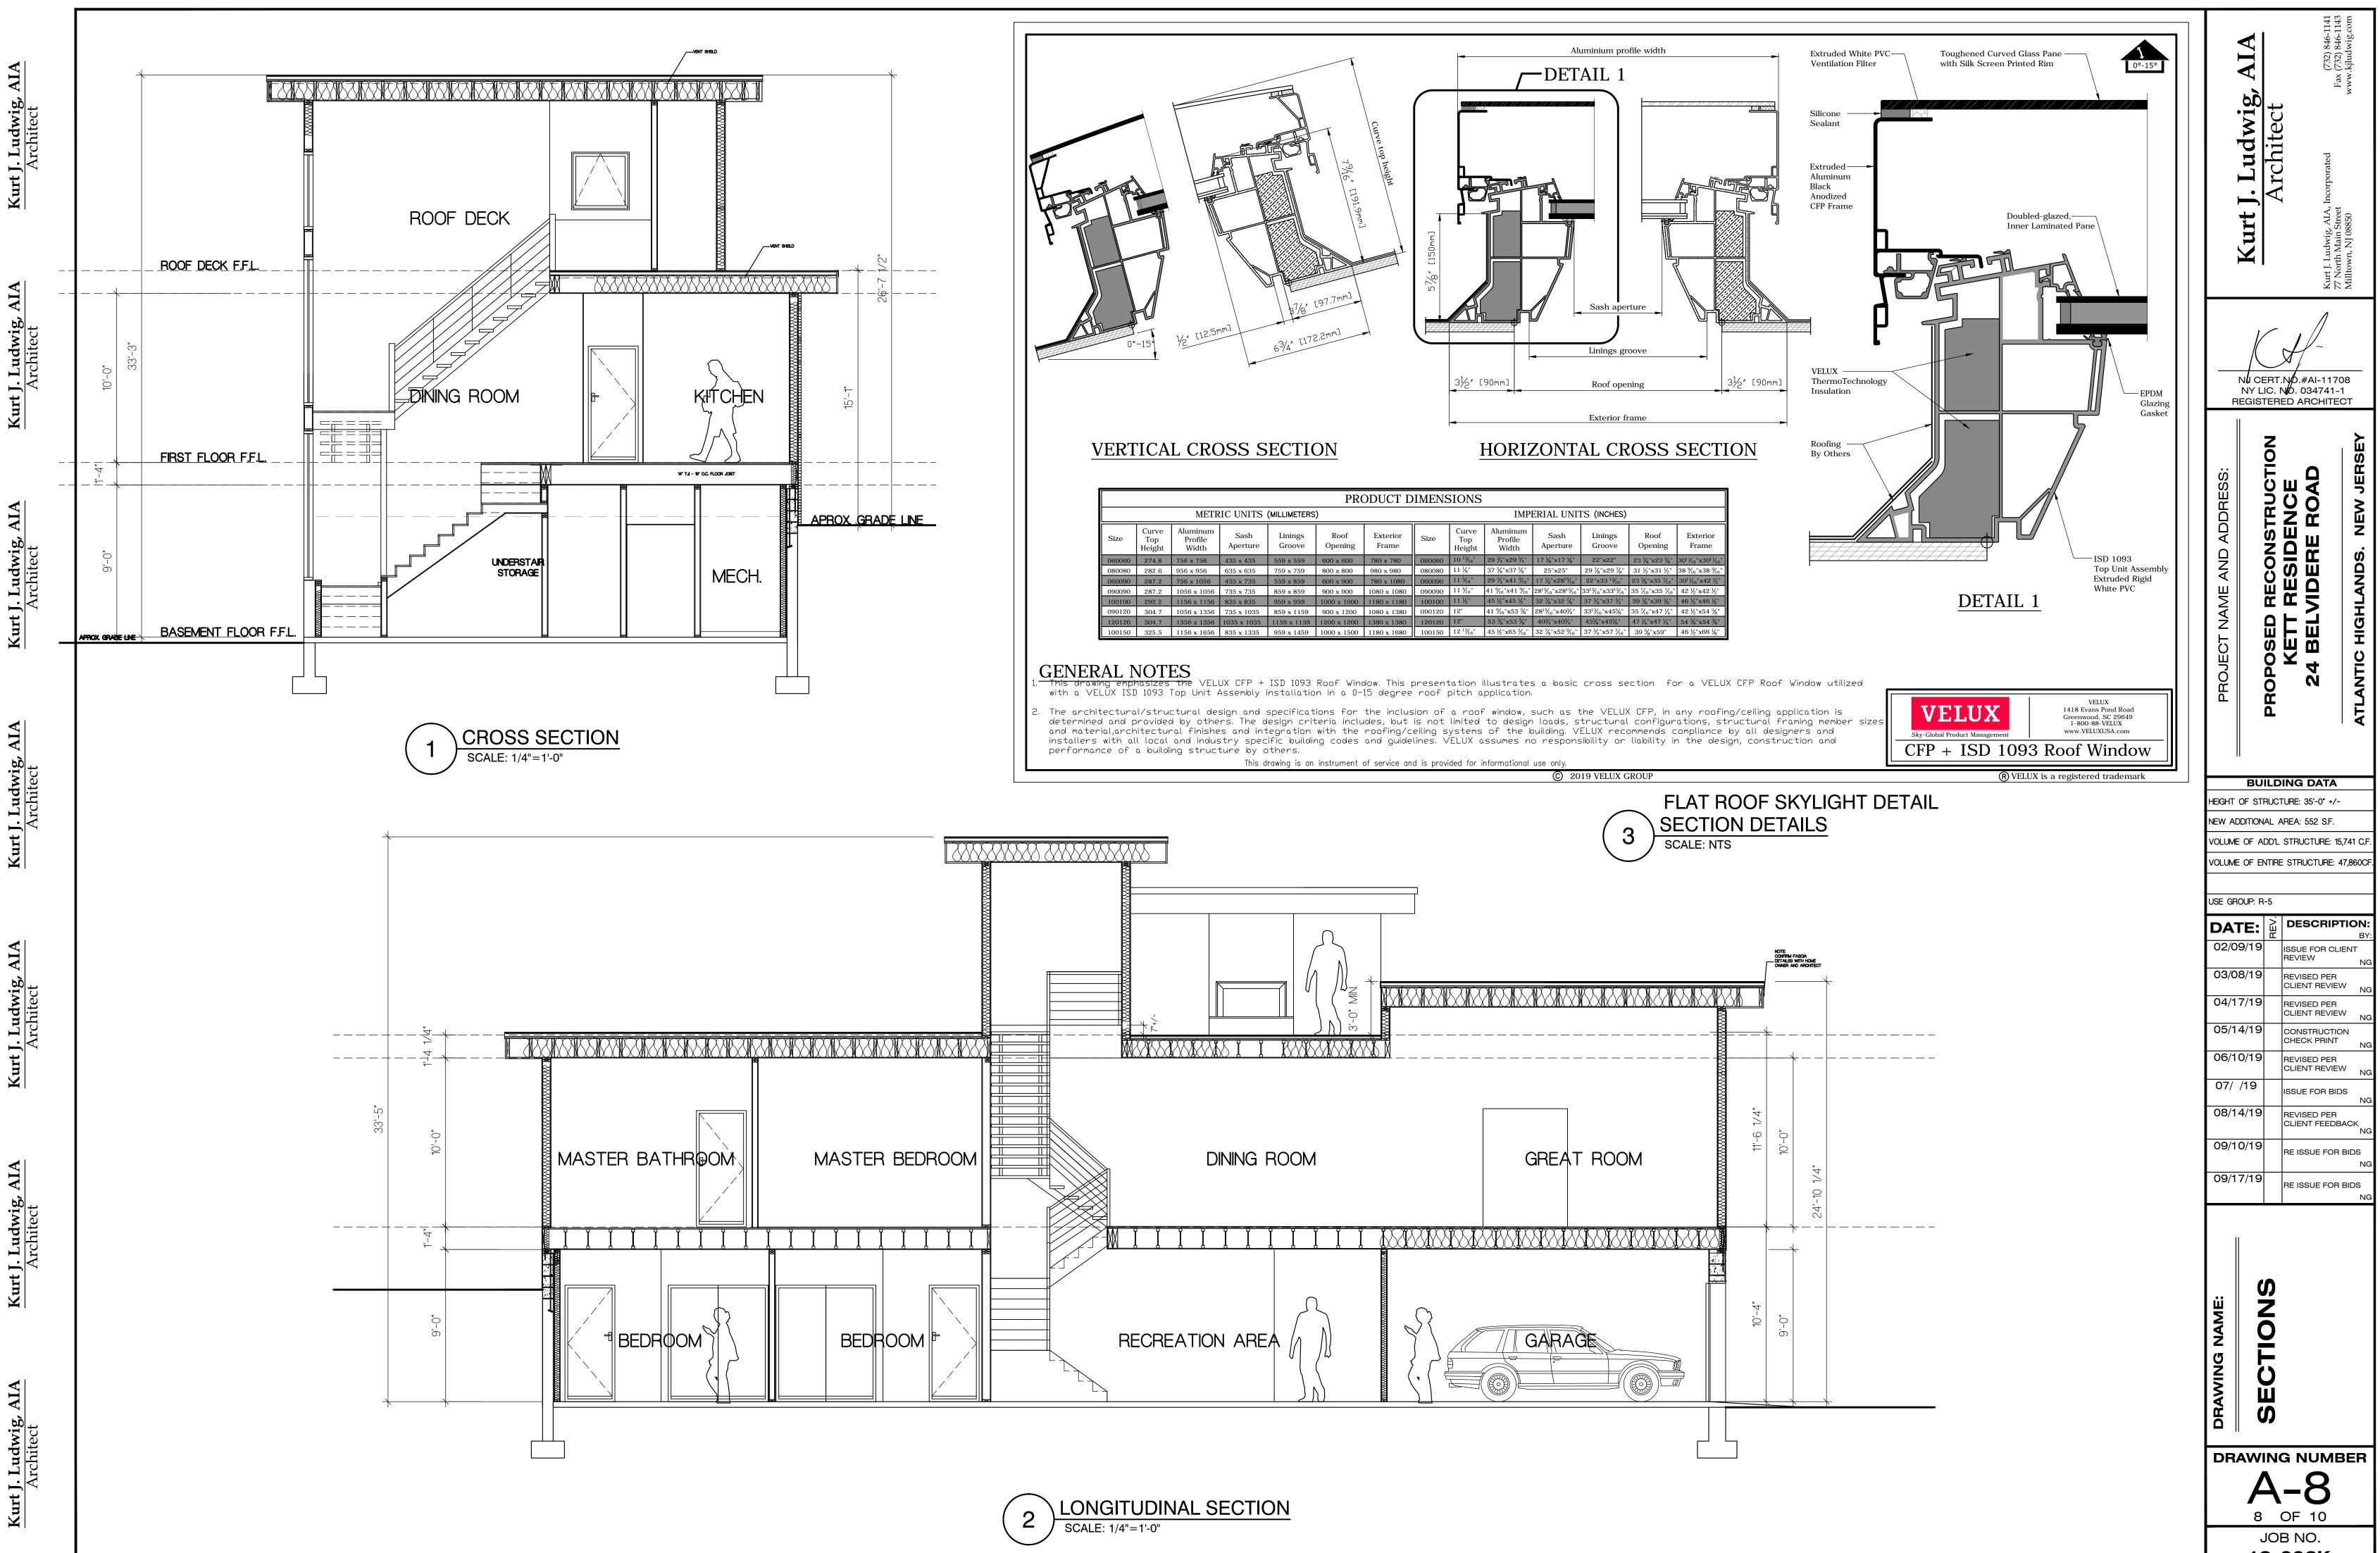

19-006K

BRACED WALL PANELS.

WALL CONSTRUCTION

For SI: 1 foot = 304.8 mm.

For SI: 1 foot = 304.8 mm.

, End of braced wall line

IN ACCORDANCE WITH 2009 NJ IRC CODE: SECTION R602.10.1.1 WALL BRACING

NOTE: ALL BRACED WALL PANELS SHALL BE CONSTRUCTED WITH THE INTERMITTENT BRACING METHODS SPECIFIED IN NJIRC R602.10.2 OR THE CONTINUOUS SHEATHING METHODS SPECIFIED IN SECTIONS R602.10.4 AND R602.10.5. (MIXING OF BRACING METHOD SHALL BE PERMITED AS PER R602.10.1.1 OF THE 2009 NJ IRC.

BRACED WALL & PANEL LOCATIONS

IN ACCORDANCE WITH 2009 NJ IRC CODE: SECTION R602.10.1.4 WALL BRACING

NOTE: ALL BRACED WALL LINES SHALL BE LOCATED IN ACCORDANCE WITH FIGURE R602.10.1.4(1) AND SHALL BE LOCATED NOT MORE THAN 25 FEET ON OF A BRACED WALL LINE IN ACCORDANCE TO FIGURE 602.10.1.4(2) AND IRC CODE SECTION R602.10.1. TOTAL COMBINED DISTANCE FROM EACH END OF A BRACED WALL LINE SHALL NOT EXCEED 12.5 FT.

BRACED WALL

LINE SPACING

FIGURE R602.10.1.4(1)

BRACED WALL PANELS AND BRACED WALL LINES

End Distance 1 + End Distance 2

Extent of braced wall line

Braced wall panel shall be permitted to be located away from the end of a braced wall line, provided the total end distance from each end to the nearest braced wall panel does not exceed 12.5'. If braced wall panel is located at the end of the braced wall line, then end distance is 0'.

FIGURE R602.10.1.4(2) BRACED WALL PANEL END DISTANCE REQUIREMENTS (SDC A, B AND C)

NOTE: WALL FRAMING NOT SHOWN

End of braced wall line

BRACED

NOTE: ALL BRACED WALLS MAY BE OFFSET OUT-OF-PLANE UP TO 4 FEET FROM THE DESIGNATED BRACED WALL LINE PROVIDED THAT THE TOTAL OUT-TO-OUT OFFSET OF CENTER AND NOT BE PERMITTED TO BEGIN MORE THAN 12.5 FT FROM THE END BRACED WALL PANELS IS NOT MORE THAN 8 FEET IN ACCORDANCE WITH FIGURES R602.10.1.4(3) AND R602.10.1.4(4)

> WALL CONSTRUCTION 8-FOOT TOTAL OUT-TO-OUT OFFSET (4 FEET EACH WAY) IN BRACED WALL LINE 4-FOOT OFFSET BRACED WALL LINE OFFSETS IN DISCONTINUOUS BRACED LINE

BRACED WALL LINE For SI: 1 foot = 304.8 mm. FIGURE R602.10.1.4(3)

OFFSETS PERMITTED FOR BRACED WALL LINES OFFSET ≤ 4' EACH DIRECTION 8' MAX. OFFSET

BWLA BWL B BWL C BRACED WALL LINE SPACING BRACED WALL LINE SPACING LOCATION OF BRACED WALL BRACED WALL LINE AT BUILDING LINE AT BUILDING NOTE: BRACED WALL SPACING FOR BWL B IS THE GREATER OF THE DISTANCE FROM BWL A TO BWL B OR FROM

> FIGURE R602.10.1.4(4) BRACED WALL LINE SPACING

For SI: 1 foot = 304.8 mm.

BRACED WALL PANEL TOTAL LENGTH (MIN.) PER WIND SPEED NOTE: TOTAL LENGTH OF REQUIRED BRACED WALL LINES SHALL CONFORM TO TABLE R602.10.1.2(1)


WALL CONSTRUCTION TABLE R602.10.1.2(1)a, b, c, d, e BRACING REQUIREMENTS BASED ON WIND SPEED EXPOSURE CATEGORY B, 30 FT MEAN ROOF HEIGHT, MINIMUM TOTAL LENGTH (feet) OF BRACED WALL PANELS REQUIRED ALONG EACH BRACED WALL LINE 9.5 3.5 6.5 5.5 9.5 31.5 15.5 30.0

INTERNATIONAL RESIDENTIAL CODE 2009, NEW JERSEY EDITION

10 F	T EAVE	/ B, 30 F TO RID WALL H ED WAL	GE HEI EIGHT,	- 1	MINIMUM TOTAL	LENGTH (feet) OF BRA	ACED WALL PANELS R	EQUIRED ALONG	
Basic Wind Speed (mph)		Story Location	1	Braced wall Line Spacing (feet)	Method LIB ^{f, h}	Method GB (doubled sided) ^g	Method DWB, WSP, SFB, PCP, HPS ^{f, i}	Continuous Sheathing	
				10	4.5	4.5	2.5	2.5	
			\wedge	20	8.5	8.5	5.0	4.0	
		\triangle	Ħ	30	12.0	12.0	7.0	6.0	
				40	15.5	15.5	9.0	7.5	
		Ш	Ш	50	19.0	19.0	11.0	9.5	
				60	22.5	22.5	13.0	11.0	
				10	8.5	8.5	5.0	4.5	
				20	16.0	16.0	9.0	8.0	
≤ 100	١,	\triangle		30	23.0	23.0	13.0	11.0	
(mph)	$ \triangle $	Н		40	29.5	29.5	17.0	14.5	
	ш			50	36.5	36.5	21.0	18.0	
				60	43.5	43.5	25.0	21.0	
				10	NP	12.5	7.5	6.0	
				20	NP	23.5	13.5	11.5	
	\triangle			30	NP	34.0	19.5	16.5	
				40	NP	44.0	25.0	21.5	
	ш			50	NP	54.0	31.0	26.5	
				60	NP	64.0	36.5	31.0	
				10	5.5	5.5	3.0	3.0	
			\triangle	20	10.0	10.0	6.0	5.0	
	١.			30	14.5	14.5	8.5	7.0	
			Н	40	18.5	18.5	11.0	9.0	
			Ш	50	23.0	23.0	13.0	11.5	
				60	27.5	27.5	15.5	13.5	
				10	10.5	10.5	6.0	5.0	
			\triangle	20	19.0	19.0	11.0	9.5	
≤ 110		\triangle		30	27.5	27.5	16.0	13.5	
(mph)	A	Н		40	36.0	36.0	20.5	17.5	
				Ш	50	44.0	44.0	25.5	21.5
				60	52.5	52.5	30.0	25.5	
				10	NP	15.5	9.0	7.5	
			\triangle	20	NP	28.5	16.5	14.0	
		\triangle	H	30	NP	41.0	23.5	20.0	
		Н		40	NP	53.0	30.5	26.0	
		Ш		50	NP	65.5	37.5	32.0	
				60	NP	77.5	44.5	37.5	

BRACED WALL METHOD (CONTINUOUS SHEATHING)

NOTE: ALL BRACED WALL LINES WITH CONTINUOUS SHEATHING SHALL BE CONSTRUCTED IN ACCORDANCE WITH SECTION R602.10.4. ALL BRACED WALL LINES ALONG EXTERIOR WALLS ON THE SAME STORY SHALL BE CONTINUOUSLY SHEATHED. SHEATHING TO BE USED ON ALL SHEATHABLE SURFACES ON ONE SIDE OF A BRACED WALL LINE INCLUDING AREAS ABOVE AND BELOW OPENINGS AND GABLE END WALLS AND SHALL BE CONSTRUCTED IN ACCORDANCE TO ONE OF THE METHODS LISTED BELOW.

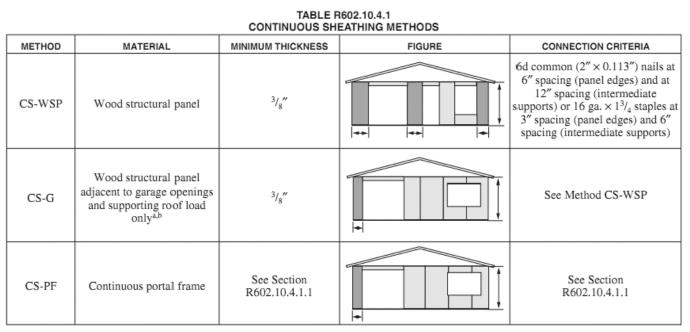

For SI: 1 inch = 25.4 mm, 1 pound per square foot = 47.89 Pa. a. Applies to one wall of a garage only. b. Roof covering dead loads shall be 3 psf or less.


a. Interpolation shall be permitted.

* NOTE: THE NUMBER OF CONTINUOUS PORTAL FRAME PANELS IN A SINGLE BRACED WALL LINE SHALL NOT EXCEED FOUR.


	ADJACENT CLEAR			WALL HEIGHT (feet)		
METHOD	OPENING HEIGHT (inches)	8	9	10	11	12
	64	24	27	30	33	36
	68	26	27	30	_	_
	72	28	27	30	_	_
	76	29	30	30	_	_
	80	31	33	30	_	_
	84	35	36	33	_	_
	88	39	39	36	_	_
	92	44	42	39	_	_
	96	48	45	42	_	_
CS-WSP	100	_	48	45	_	_
	104	_	51	48	_	_
	108	_	54	51	_	_
	112	_	_	54	44	_
	116	_	_	57	_	_
	120	_	_	60	_	_
	122	_	_	_	_	48
	132	_	_	_	66	_
	144	_	_	_	_	75
CS-G	≤ 120	24	27	30	_	_
CS-PF	≤ 120	16	18	20	_	_


WALL CONSTRUCTION SEE TABLE R602.3(1) FOR FASTENING MINIMUM 24 IN. WOOD STRUCTURAL PANEL OR 32 IN. STRUCTURAL FIBERBOARD SHEATHING CORNER RETURN , ORIENTATION OF STUD MAY VARY SEE FIGURE R602.3(2 (a) OUTSIDE CORNER DETAIL NOTE: CORNER DETAILS FOR CONTINUOUS SHEATHING TO 16D NAIL (3½"× 0.131") 2 ROWS AT 24 IN. O.C. CONFIRM TO FIGURE CONTINUOUS WOOD STRUCTUR PANEL OR STRUCTURAL FIBER-BOARD BRACED WALL LINE R602.10.4.4(1) (a).(b).(c) (c) GARAGE DOOR CORNER For SI: 1 inch = 25.4 mm, 1 foot = 305 mm. FIGURE R602.10.4.4(1)
TYPICAL EXTERIOR CORNER FRAMING FOR CONTINUOUS SHEATHING


			SPACING OF FASTENERS		
ITEM	DESCRIPTION OF BUILDING MATERIALS	DESCRIPTION OF FASTENER ^{b, c, e}	Edges (inches) ⁱ	Intermediate supports ^{c, e} (inches)	
Woo	d structural panels, subfloor, ro	oof and interior wall sheathing to framing and particleb	oard wall sheathing to	framing	
30	3/8" - 1/2"	6d common (2"×0.113") nail (subfloor wall) 8d common (2 ¹ / ₂ "×0.131") nail (roof)	6	128	

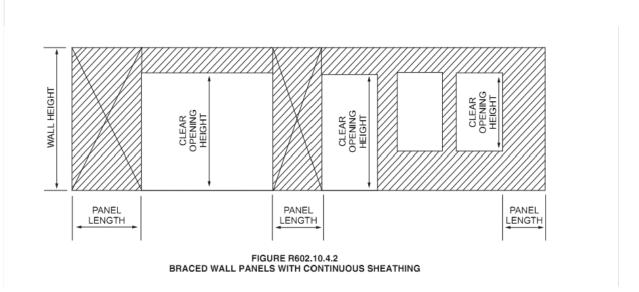

NOTE: A MIN. 24" WOOD STRUCTURAL PANEL CORNER RETURN SHALL BE PROVIDED AT BOTH ENDS OF A BRACED WALL LINE ACCORDING WITH FIG. R602.10.4.4(1), (2). IN LIEU OF THE CORNER RETURN, A HOLD-DOWN DEVICE WITH A MINIMUM UPLIFT DESIGN VALUE OF 800 LBS SHALL BE FASTENED TO THE CORNER STUD AND TO THE FOUNDATION/FRAMING BELOW ACCORDING WITH FIG. R602.10.4.4(3)

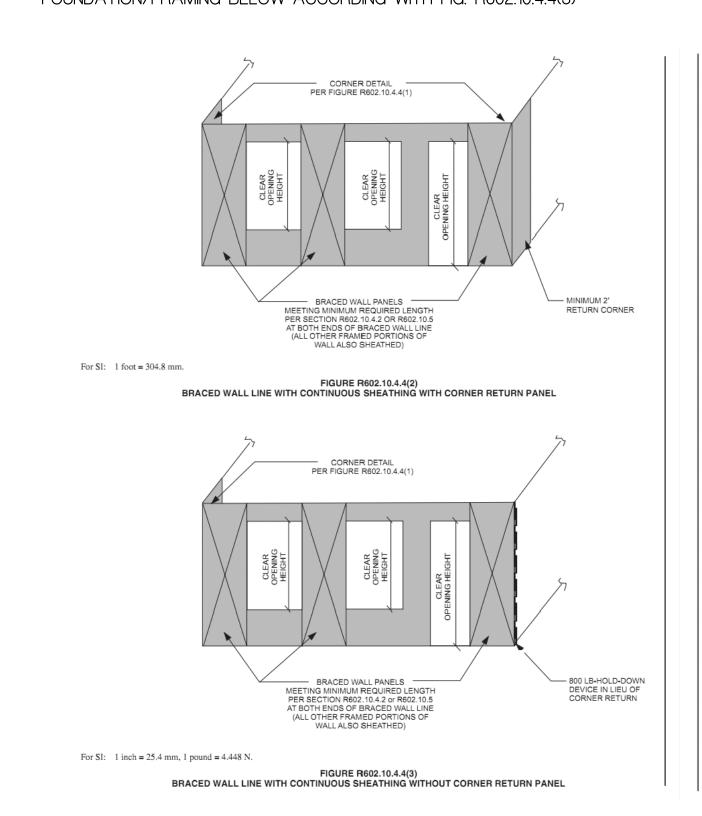

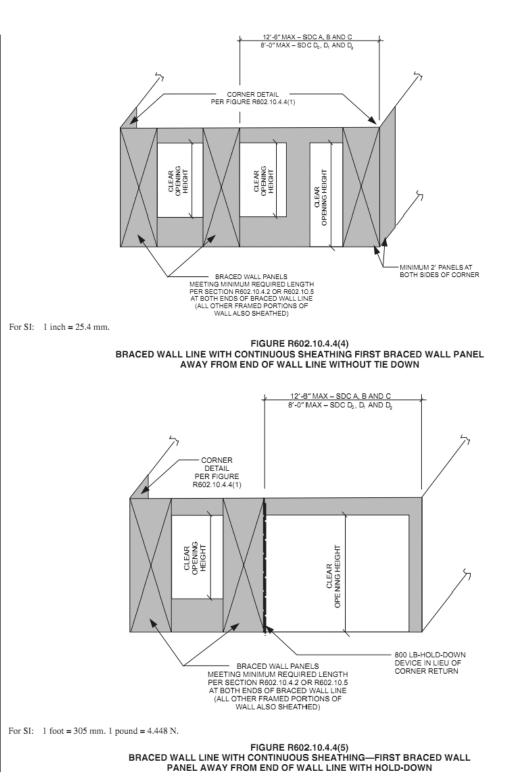

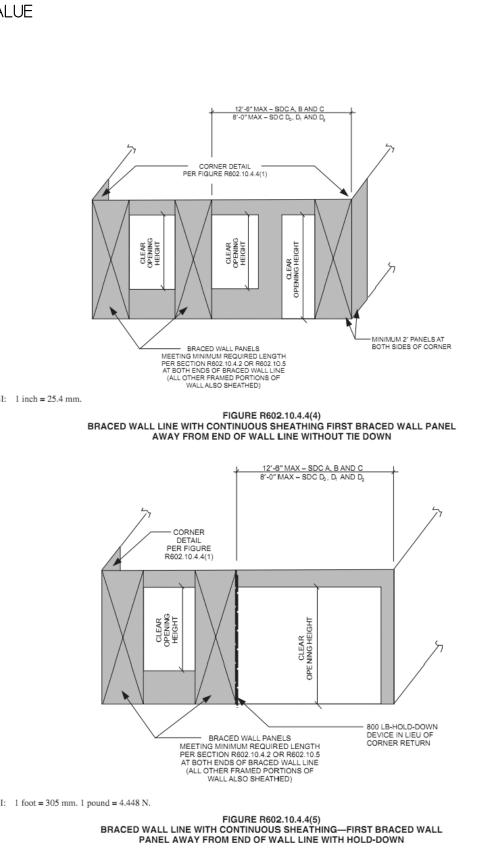



BUILDING DATA HEIGHT OF STRUCTURE: 35'-0" +/-NEW ADDITIONAL AREA: 552 S.F. VOLUME OF ADD'L STRUCTURE: 15,741 (

VOLUME OF ENTIRE STRUCTURE: 47,8600


USE GROUP: R-5 ISSUE FOR CLIENT 03/08/19 REVISED PER CLIENT REVIEW REVISED PER CLIENT REVIEW 05/14/19 CONSTRUCTION ICHECK PRINT REVISED PER CLIENT REVIEW ISSUE FOR BIDS REVISED PER CLIENT FEEDBACK

09/10/19 RE ISSUE FOR BIDS 09/17/19 RE ISSUE FOR BIDS

DRAWING NUMBER

OF 10 JOB NO. 19-006K



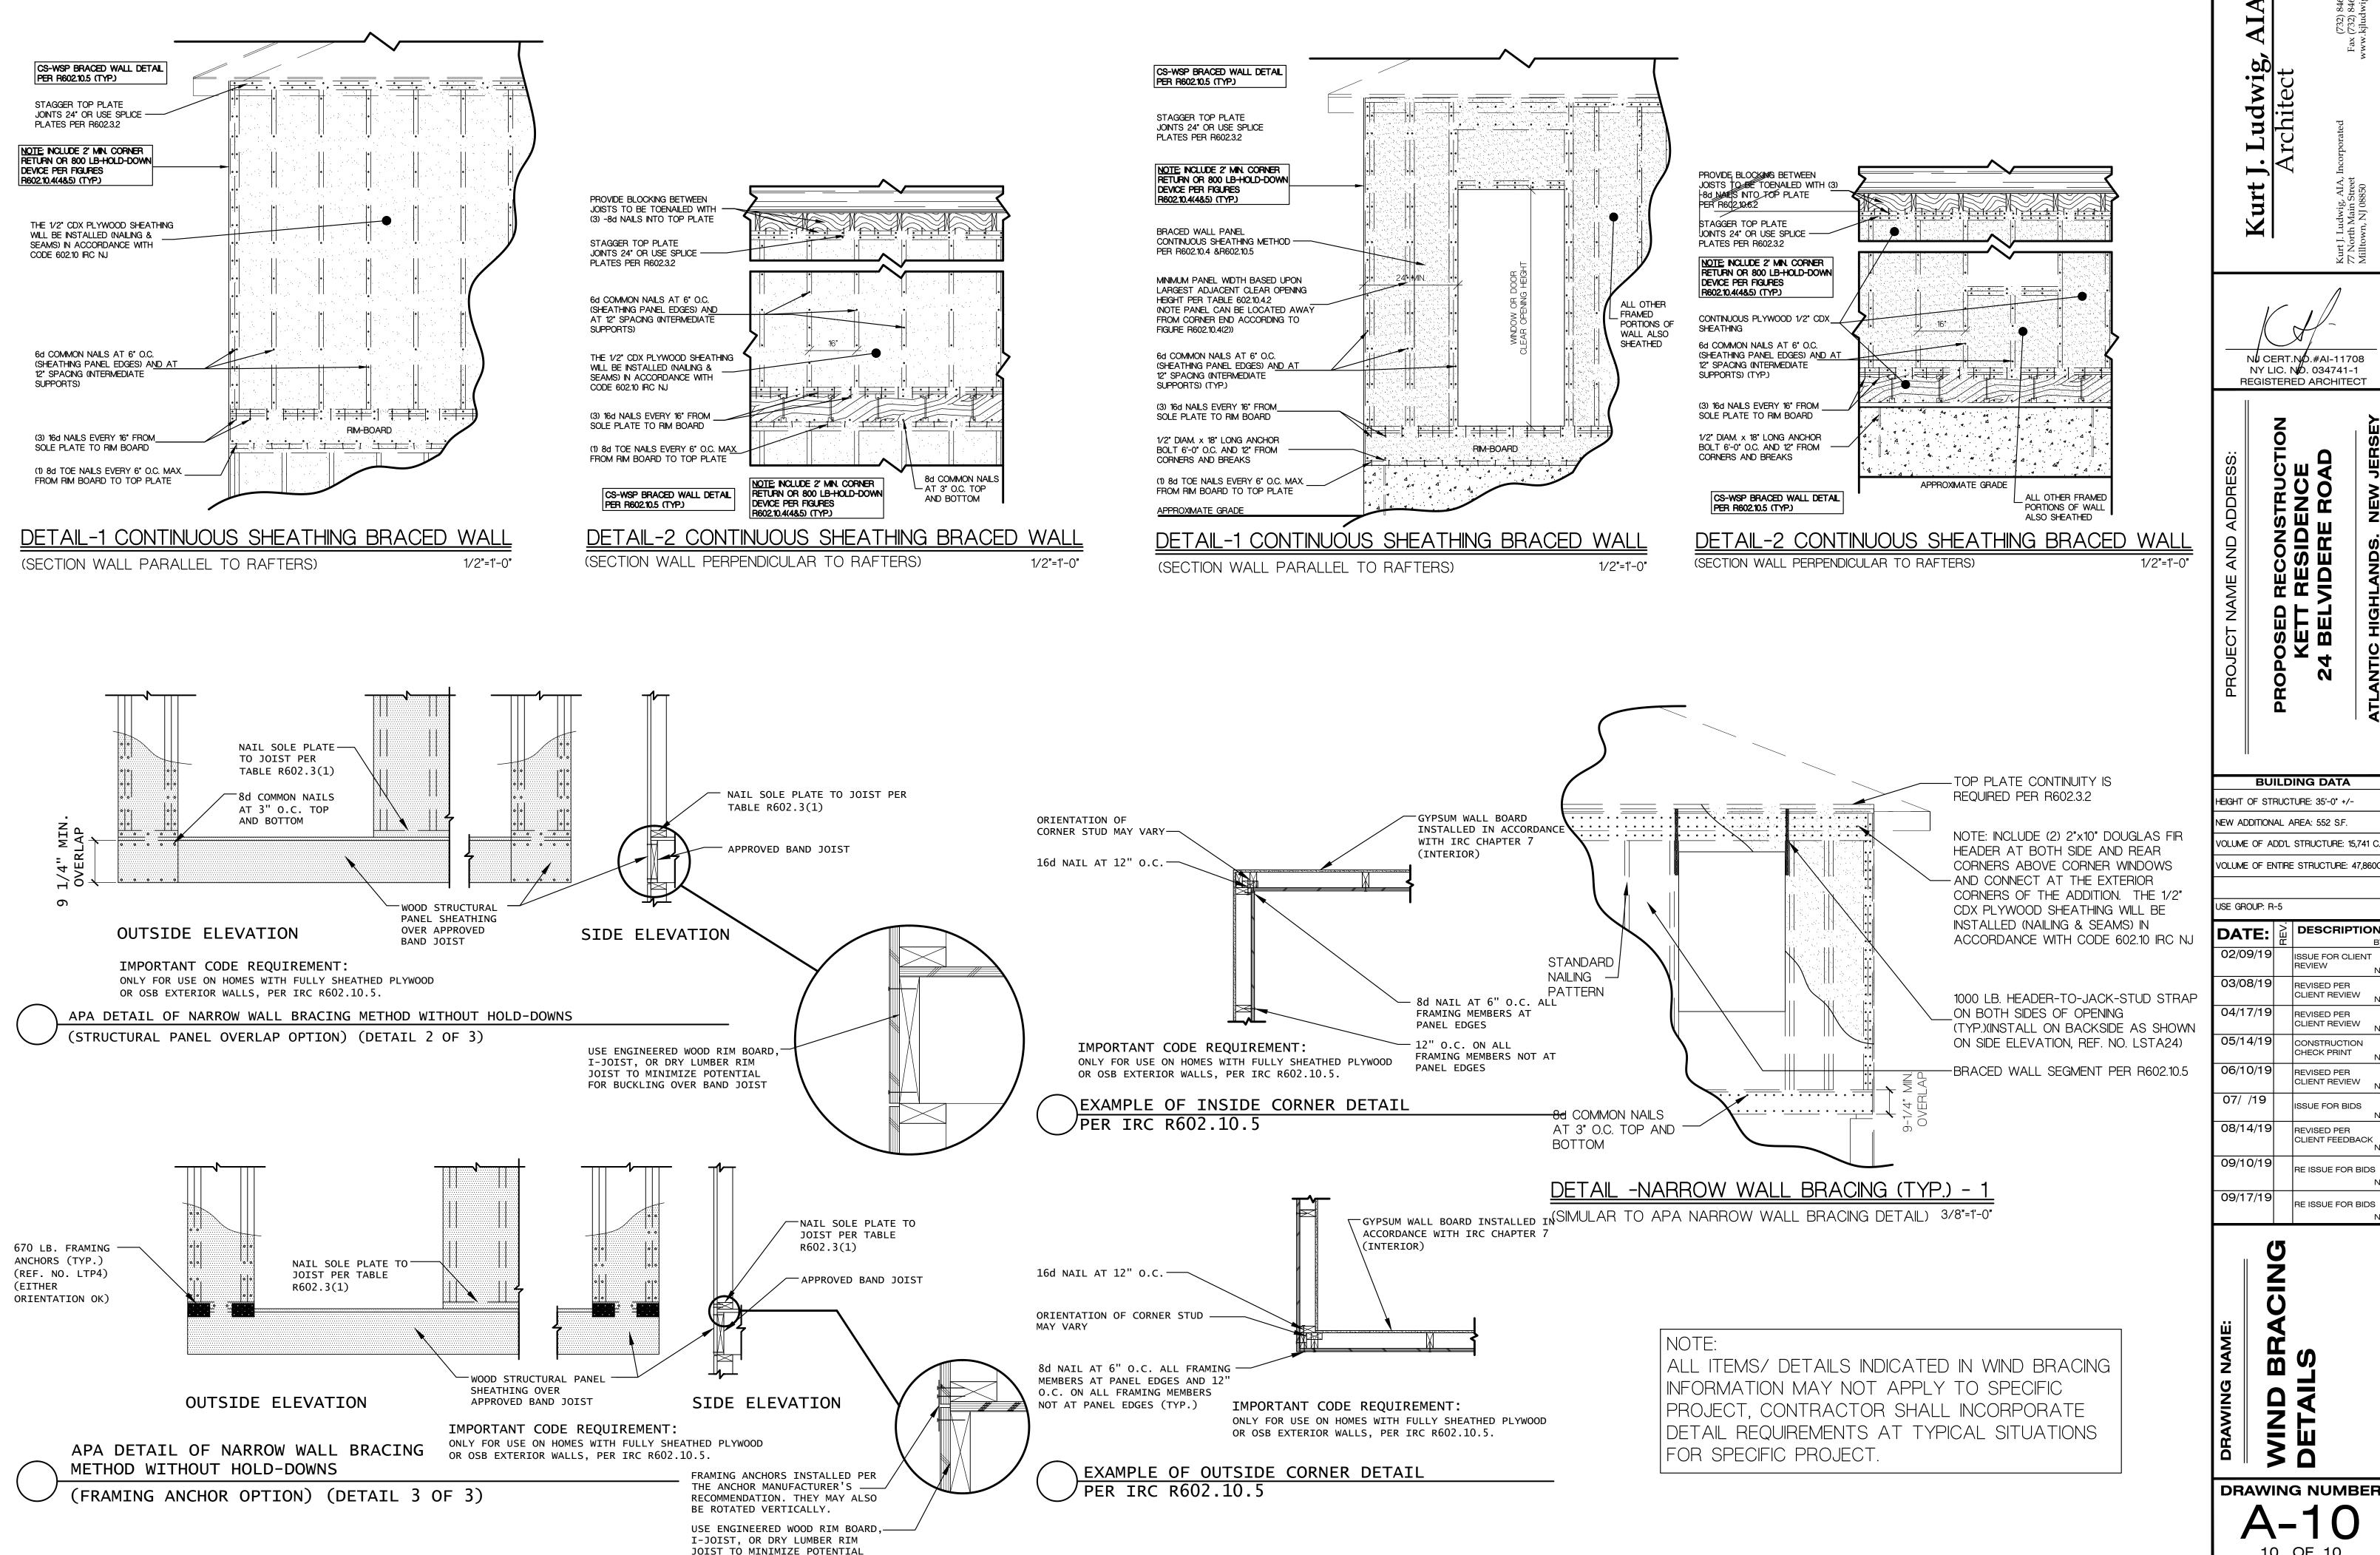

FOR BUCKLING OVER BAND JOIST

N CERT.N**/**D.#AI-11708 NY LIC. NO. 034741-1 REGISTERED ARCHITECT

ECON: ESID DERE

BUILDING DATA HEIGHT OF STRUCTURE: 35'-0" +/-NEW ADDITIONAL AREA: 552 S.F. /OLUME OF ADD'L STRUCTURE: 15,741 (

USE GROUP: R-5

DATE: DESCRIPTION: 02/09/19 ISSUE FOR CLIENT 03/08/19 REVISED PER CLIENT REVIEW 04/17/19 REVISED PER CLIENT REVIEW 05/14/19 CONSTRUCTION CHECK PRINT 06/10/19 REVISED PER CLIENT REVIEW ISSUE FOR BIDS 08/14/19 REVISED PER CLIENT FEEDBACK 09/10/19 RE ISSUE FOR BIDS

RE ISSUE FOR BIDS

DRAWING NUMBER 10 OF 10

> JOB NO. 19-006K